The second secon

OFFICE OF THE SHERIFF

Chad Chronister, Sheriff Donna Lusczynski, Chief Deputy Hillsborough County, Florida

July 9, 2019

SUBJECT: Amendment #1 to RFP 13-19 Falkenburg Road Jail Building #14 and Housing Unit #2 Partial Roof Replacement

MESSAGE: Please note and acknowledge the following changes or additions to be included in the referenced section(s) of RFP 13-19:

1. Amendment to Exhibit A – JVB Architect Roof Renovation Design Documents are posted as Exhibit A, Amendment #1 Design Documents:

The following drawings have been revised, and are included:

- 1) A-002 Existing/Demo Roof Plan Building 14
- 2) A-003 Existing/Demo Roof Plan Building 2
- 3) A-101 Roof Plan Building 14
- 4) A-102 Roof Plan Building 2

Please note that this document hereby becomes part of RFP 13-19 and without this document, the RFP is considered incomplete.

Sincerely,

Christina R. Porter, CPA Chief Financial Officer

ahrt up to

CRP/drj

Enclosures

ACKNOWLEDGEMENT OF AMENDMENT

We do hereby acknowledge the information and/or changes described in the Amendment #1 to Bid 13-19.

PLEASE PRIN	NT – Company Name:
	By:
	Title:
	Date:
Signature:	
	(Signed Acknowledgement must be included with your Proposal Response

3*

JVB ARCHITECT, LLC

ARCHITECTURE PLANNING INTERIORS

RFP 13-19 Falkenburg Road Jail Building #14 and Housing Unit #2 Partial Roof Replacement Amendment #1

PROJECT NAME: HILLSBOROUGH COUNTY SHERIFF'S OFFICE

ROOF RENOVATION 520 N. Falkenburg Road Tampa, FL 33619

DATE: 7-8-2019

To: ALL PROPOSERS

ARCHITECTURAL REVISIONS:

<u>Clarifications</u>: The following updated drawings dated 7-8-2019 have been modified as follows below to provide clarifications on questions/concerns brought to our attention at the Pre-Bid meeting.

A-002 EXISTING/DEMO ROOF PLAN BUILDING 14:

- 1. Existing roof insulation thickness has been added to Existing/Demo Roof Plan (North) Existing roof insulation thickness has been added to Existing/Demo Roof Plan (South)
- 2. Note #11 of the "Demolition General Notes", added "Owner to provide letter of recertification for lighting protection system as required".
- 3. Note #3 of the "Keynote Legend", added "Uninstall and reinstall at same locations, as needed".
- 4. Note #7 of the "Keynote Legend", replaced "Remove existing flashing" with "Provide new skirt flashing around existing curb flashing".

A-003 EXISITNG/DEMO ROOF PLAN BUILDING 2:

- Existing roof insulation thickness has been added to Existing/Demo Roof Plan (West)
 Existing roof insulation thickness has been added to Existing/Demo Roof Plan (East)

 Existing roof insulation thickness has been added to Existing/Demo Roof (Cueing Area)
- 2. Note #11 of the "Demolition General Notes", added "Owner to provide letter of recertification for lighting protection system as required".
- 3. Note #3 of the "Keynote Legend", added "Uninstall and reinstall at same locations, as needed".

A-101 ROOF PLAN BUILDING 14:

- 1. Note #14 of the "Keynote Legend", updated to the following: "New Cricket Area to be achieved with tapered insulation, typ. Maintain a minimum of 8" height at existing parapet. If unable to maintain 8" minimum height after cricketing, wrap roofing membrane over existing parapet and provide roof drip edge.
- 2. Tags have been added throughout the floor plans pointing to various roof details to identify different typical roof conditions.
- 3. Angled parapet locations have been identified.
- 4. Sloping directions of existing metal roofs have been identified.

A-102 ROOF PLAN BUILDING 2:

- 1. Tags have been added throughout the floor plans pointing to various roof details to identify different typical roof conditions.
- 2. Angled parapet locations have been identified.
- 3. Sloping directions of existing metal roofs have been identified.

HILLSBOROUGH COUNTY SHERIFF'S OFFICE ROOF RENOVATION

520 N Falkenburg Road

Tampa, Florida 33619


ENERGY CONSERVATION PROJECT TEAM: CH 4 - COMMERCIAL ENERGY EFFICIENCY **ARCHITECT:** CLIMATE ZONE 2 (HILLSBOROUGH COUNTY) JVB ARCHITECT, LLC **BUILDING ENVELOPE SYSTEM** 1719 N. HOWARD AVENUE SUITE 201 COMPONENT VALUE TAMPA, FLORIDA 33607 ROOF R-VALUE WALL R-VALUE (MASONRY) .. NELSON@JVBARCHITECT.COM ... NELSON ITURBIDES **SHEET INDEX WIND CHART BUILDING INFO** The information below was calculated using the provisions of the 2017 BUILDING TYPE: II-B Florida Building Code. FIRE PROTECTION: BUILDING IS FULLY SPRINKLERED TITLE SHEET, CODE INFORMATION & APPROVALS A-002 EXISTING ROOF PLAN BUILDING 14 OCCUPANCY TYPE: INSTITUTIONAL (1-3) Floor and Roof Live Loads A-003 EXISTING ROOF PLAN BUILDING 2 ROOF PLAN BUILDING 14 ROOF AREAS: Floor Live Loads. ROOF PLAN BUILDING 2 ROOF PHOTOS NORTH OF BUILDING 14 A-103 ROOF BUILDING 2 40 psf Cell Blocks: ROOF PHOTOS SOUTH OF BUILDING 14 WEST - 2,395 SF (VIF) A-105 ROOF PHOTOS SOUTH OF BUILDING 14 100 psf EAST - 2,400 SF (VIF) Corridors: A-106 ROOF PHOTOS WEST OF BUILDING 2 ROOF BUILDING 14 Roof Live Loads.. ROOF PHOTOS EAST OF BUILDING 2 NORTH - 1,835 SF (VIF) TYPICAL ROOF DETAILS 20 psf uniform; 300 lbs concentrated SOUTH - 3,470 SF (VIF) TYPICAL ROOF DETAILS Wind Design Data **CODES - STATE OF FLORIDA** Ultimate Wind Speed: 140 mph Nominal Wind Speed: 108 mph Risk Category: Wind Exposure: FBC - FLORIDA BUILDING CODES 6TH EDITION (2017): 4.10 ft. End Zone Width: Enclosure Classification: Enclosed BUILDING CODE **Internal Pressure Coefficient:** 0.18 + / -EXISTING BUILDING CODE MECHANICAL CODE +16.0 psf max., -35.3 psf min. Roof Zone 1: PLUMBING CODE NEC - NATIONAL ELECTRIC CODE 2014 EDITION Roof Zone 2: +16.0 psf max., -59.2 psf min. Roof Zone 3: +16.0 psf max., -89.0 psf min. PRODUCT APPROVAL INFORMATION: Roof at Zone 2 Overhangs: -50.8 psf min. Roof at Zone 3 Overhangs: -83.7 psf min. PRODUCT CATEGORY MANUFACTURER APPROVAL NO. BUILDING CODE (FBC Wall Zone 4: +35.3 psf max., -38.2 psf min. ROOFING, TPO FL5293-R33 5293.1 2017 6th ED. Wall Zone 5: +35.3 psf max., -47.2 psf min. The Ultimate Wind Speed was used to determine the above Component and Cladding Design Pressures. All exterior glazed openings shall be protected from wind-borne debris as per Section 1609.1.2 of the code. The site of this building is not subject to special topographic wind effects as per Section 1609.1.1.1 of the code. **Geotechnical Information** Design Soil Load-Bearing Capacity: 2,000 psf Flood Design Data Flood Zone:

PROJECT SCOPE:


THE PROJECT IS LIMITED TO NEW ROOF INSTALLATION. THE EXISTING BUILDING OCCUPANCY CLASSIFICATION, FIRE PROTECTION ELEMENTS, MEANS OF EGRESS, ACCESSIBILITY FEATURES AND SPATIAL LAYOUT WILL REMAIN. NO LIFE SAFETY FEATURES WILL BE DIMINISHED. THE PROJECT SCOPE ELEMENTS ARE GENERALLY DESCRIBED AS FOLLOWS:

- 1. INSTALLATION OF A NEW ROOFING MEMBRANE SYSTEM ON RIGID COVER BOARD OVER EXISTING ROOF.
- 2. REMOVAL AND REPLACEMENT OF THE ROOFING MEMBRANE SYSTEM, ALONG WITH THE INSULATION, AT PORTION OF ROOF ON GUTTER SIDE OF WEST BUILDING 2.
- 3. REMOVAL AND REPLACEMENT OF THE FLASHING
- 4. REMOVAL AND REINSTALLATION OF ROOFTOP MECHANICAL SYSTEMS AND EQUIPMENT AS REQUIRED FOR NEW ROOF MEMBRANE INSTALLATION.
- 5. REMOVAL OF SIX UNUSED ROOF STANDS ON BUILDING 14, SOUTH ROOFING.

VICINITY MAP

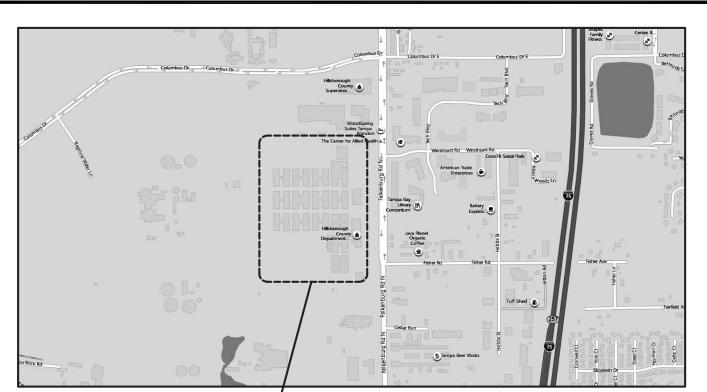

SITE LOCATION, N.T.S.

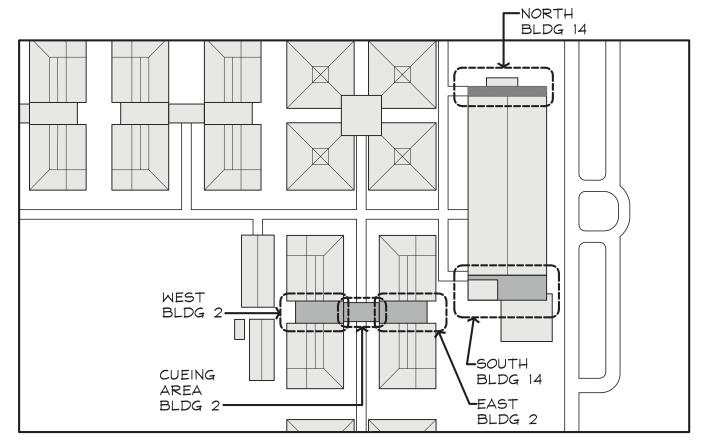

AREAS OF WORK

Tampa, Florida 33607
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FINAL OWNER REVIEW SET 7-8-2

1719 N. Howard Avenue

LLSBOROUGH COUNTY IERRIF'S OFFICE OF RENOVATION

Joseph V. Belluccia, AIA

FL REG AR92396

I CERTIFY TO THE BEST OF MY KNOWLEDGE THAT THE DRAWINGS & SPECIFICATIONS COMPLY WITH THE APPLICABLE MINIMUM BUILDING CODES


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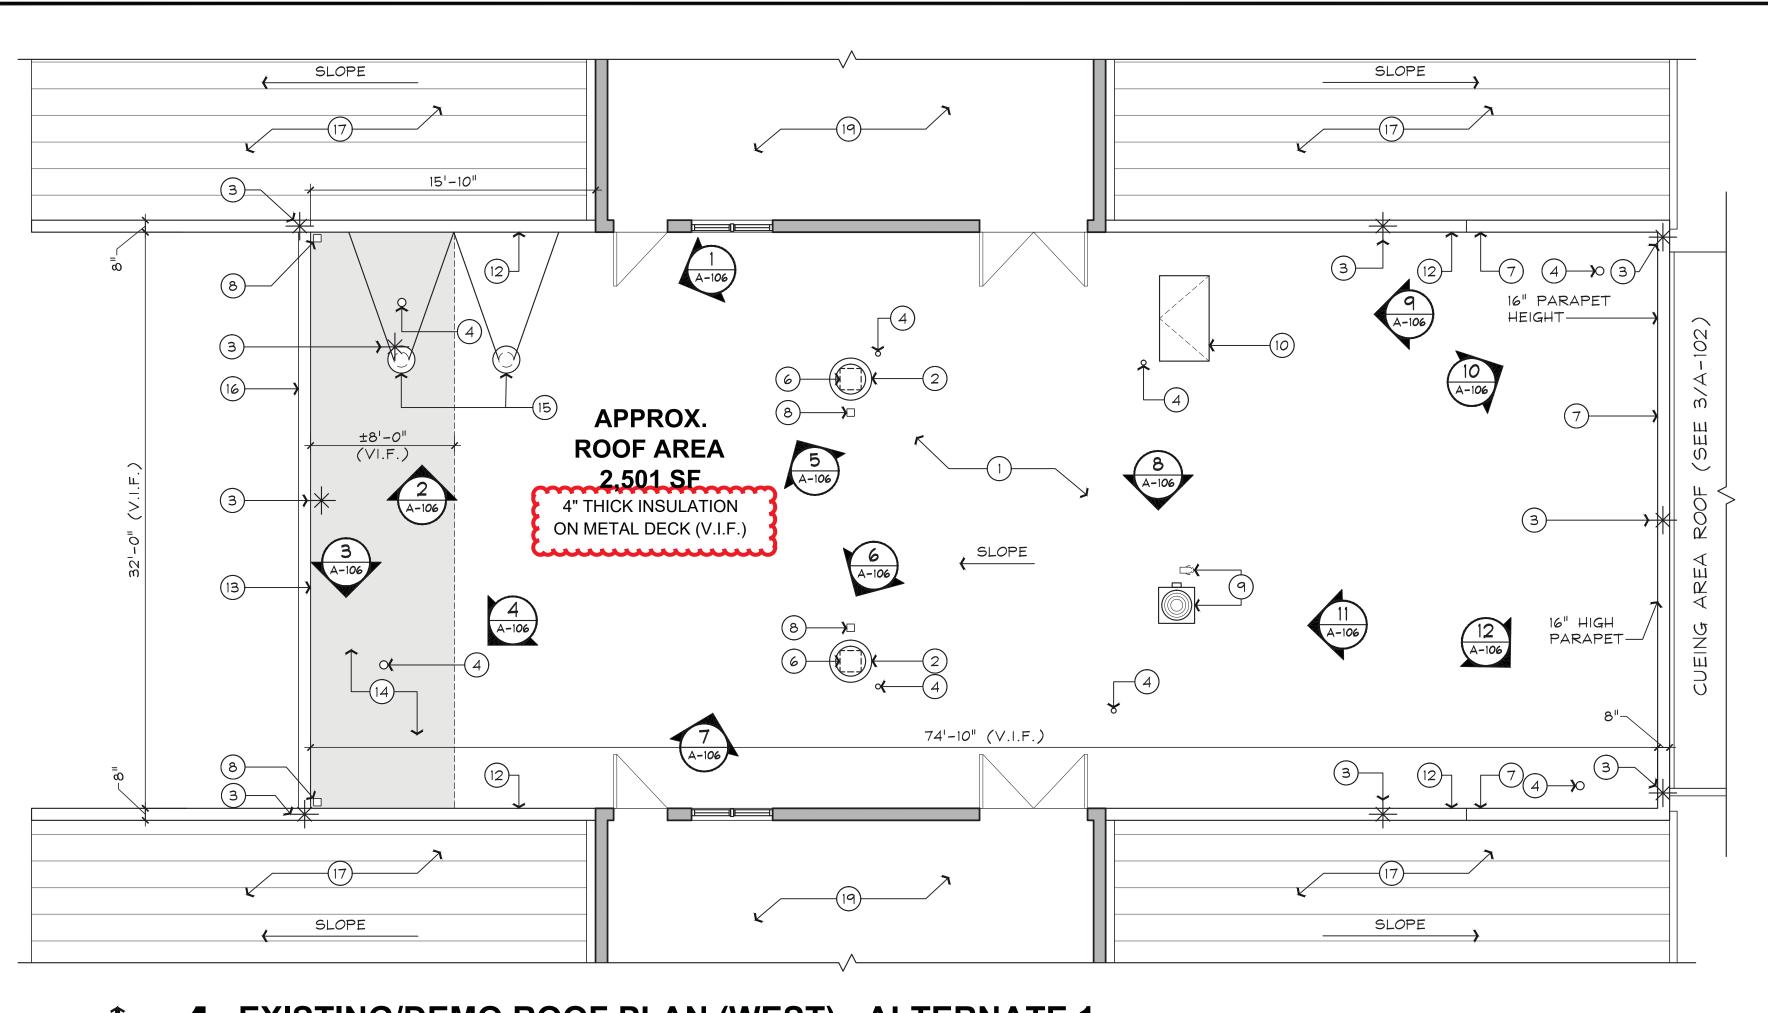
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ISSUE DATE :


SHEET TITLE:
TITLE SHEET, CODE INFORMATION & APPROVALS


SHEET NUMBER
A-001



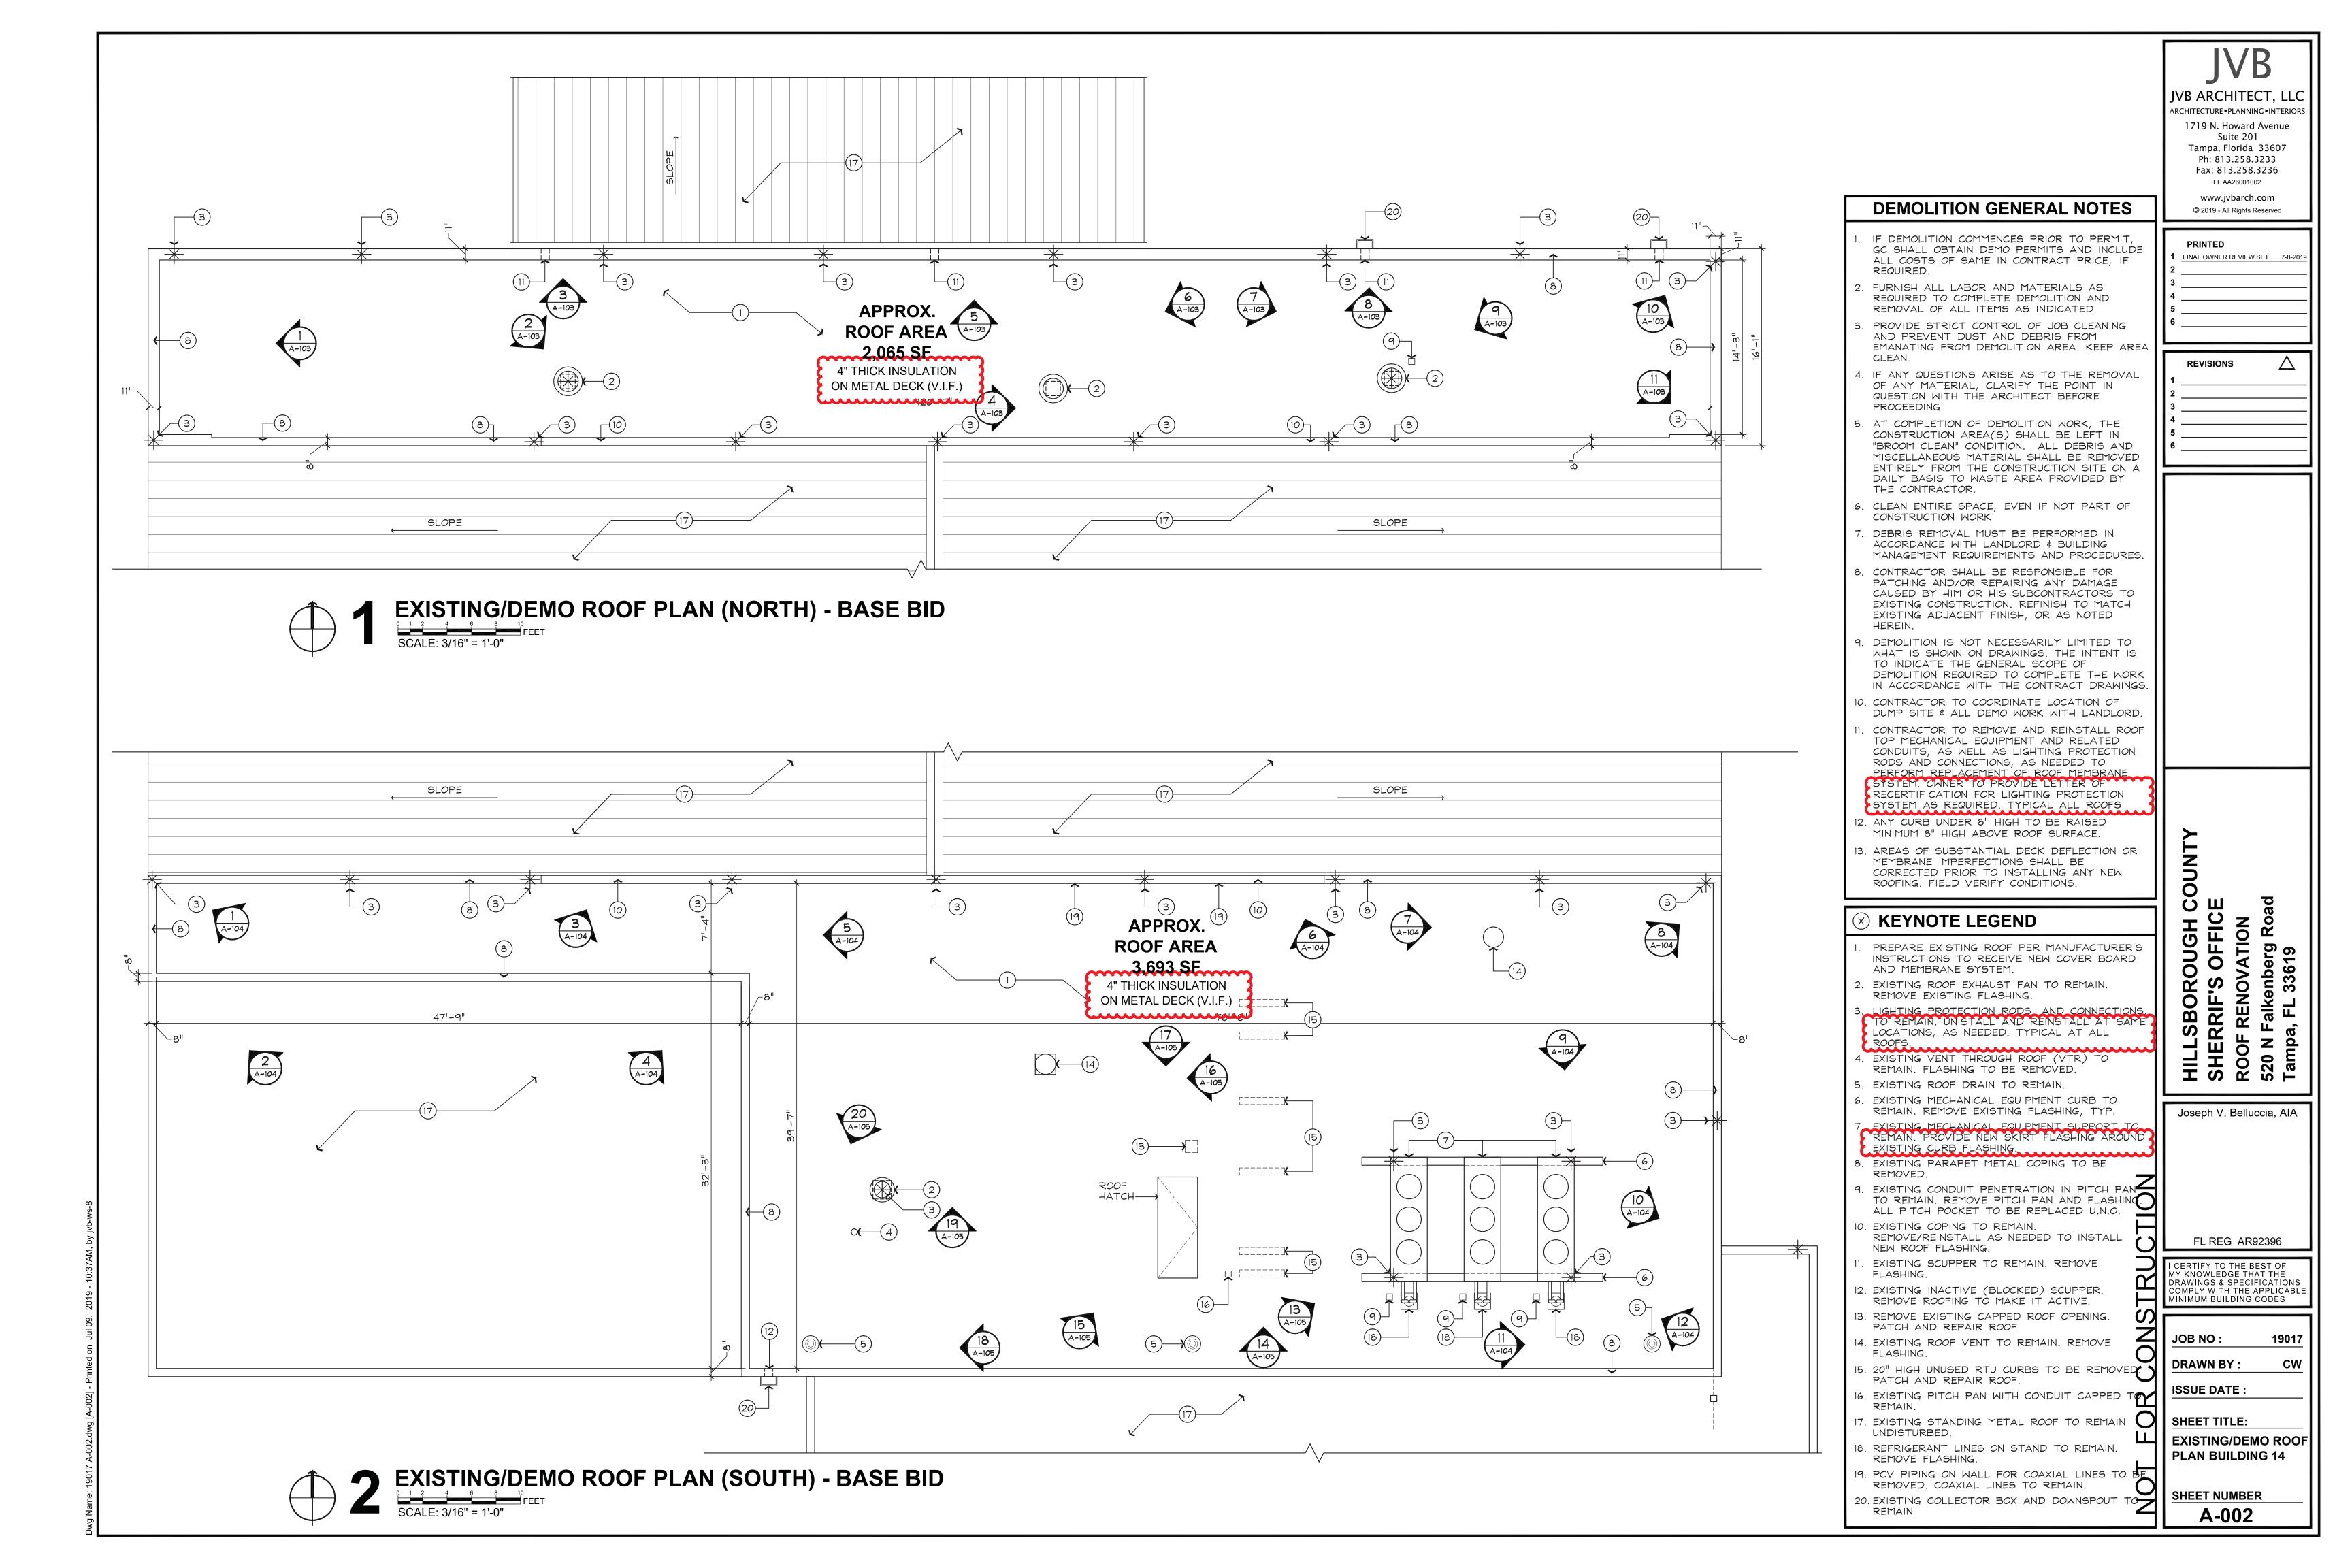

EXISTING/DEMO ROOF PLAN (WEST) - ALTERNATE 1

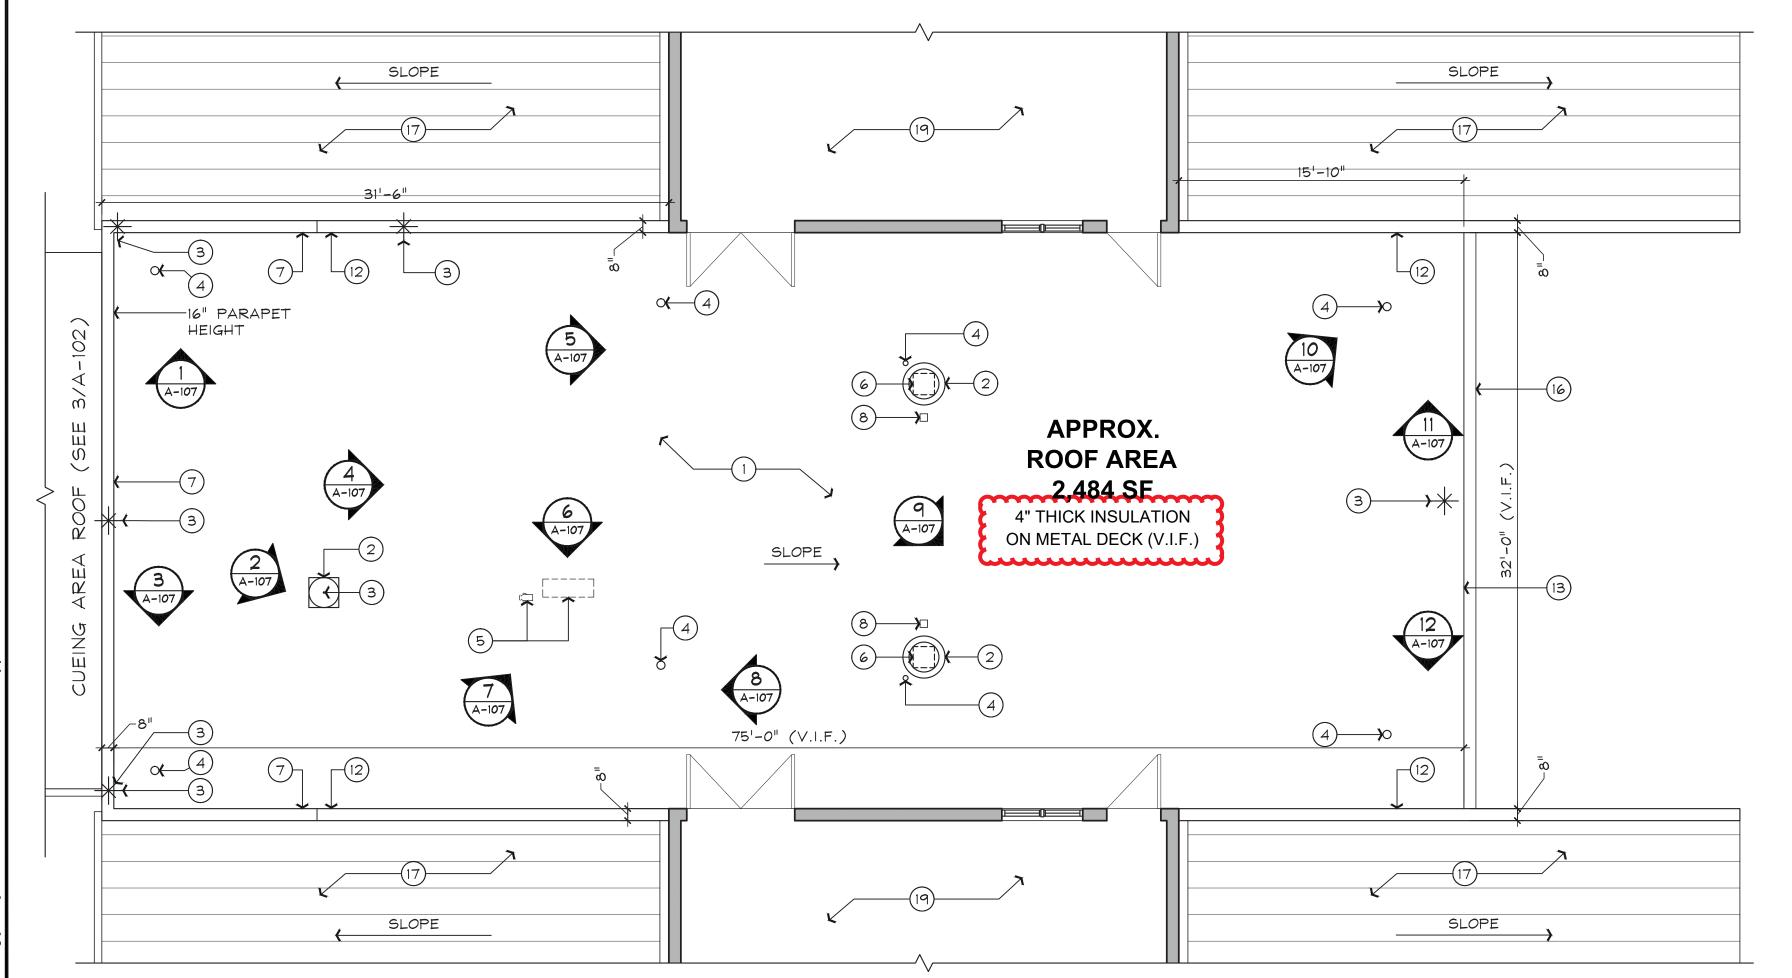

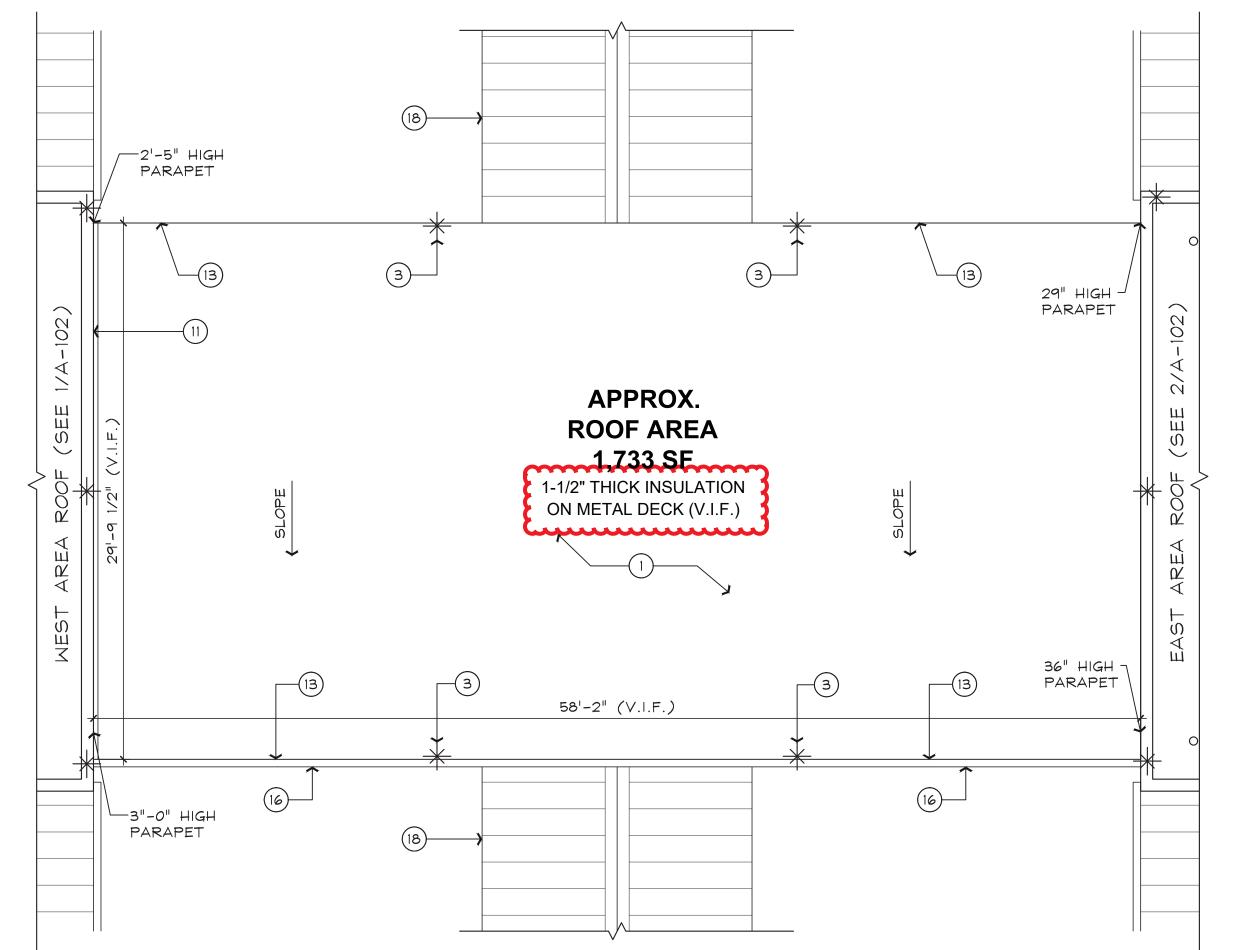

EXISTING/DEMO ROOF PLAN (CUEING AREA) - ALTERNATE 3

SCALE: 3/16" = 1'-0"

KEYNOTE LEGEND

- PREPARE EXISTING ROOF PER MANUFACTURER'S INSTRUCTIONS TO RECEIVE NEW COVER BOARD AND MEMBRANE SYSTEM.
- EXISTING ROOF EXHAUST FAN TO REMAIN. REMOVE EXISTING FLASHING.

TO REMAIN. UNINSTALL AND REINSTALL AT SAME LOCATIONS AS NEEDED, TYPICAL AT ALL ROOFS.

EXISTING VENT THROUGH ROOF (VTR) TO REMAIN. FLASHING TO BE REMOVED.

- EXISTING EXISTING SPLIT SYSTEM EQUIPMENT AND REFRIGERANT LINES TO BE REMOVED BY OWNER. PATCH & REPAIR ROOF.
- . EXISTING MECHANICAL EQUIPMENT CURB TO REMAIN. REMOVE EXISTING FLASHING, TYP. EXISTING PARAPET METAL COPING TO BE REMOVED.
- . EXISTING CONDUIT PENETRATION IN PITCH PAN TO REMAIN. REMOVE PITCH PAN AND FLASHING. ALL PITCH POCKET TO BE REPLACED U.N.O.
- . COORDINATE WITH OWNER ALL PHASES OF REMOVAL AND REINSTALLATION OF ELECTRICAL PIPING, REFRIGERANT LINES AND EQUIPMENT AT ICE MAKER CONDENSING UNIT.
- 10. EXISTING ROOF ACCESS HATCH TO REMAIN. EXISTING BUILDING EXPANSION JOINT AND FLASHING TO BE REMOVED
- 12. EXISTING COPING TO REMAIN. REMOVE/REINSTALL AS NEEDED TO INSTALL NEW ROOF FLASHING.
- 13. EXISTING ROOF EDGE FLASHING TO BE REMOVED.
- 4. SHADED AREA INDICATES LIMITS OF PORTION OF EXISTING INSULATION TO BE REMOVED DOWN TO EXISTING DECK.
- 15. EXISTING 6' HIGH VENT STACKS. REMOVE FLASHING.SUPPORT STRAPS ATTACHED TO WALL TO BE REPLACED WITH CODE COMPLIANT TIE
- 16. GUTTER SYSTEM TO BE REMOVED. 7. EXISTING STANDING METAL ROOF TO REMAIN UNDISTURBED.
- 18. EXISTING COVERED WALKWAY ROOF BELOW, NOT IN CONTRACT (N.I.C.)
- 19. EXISTING STRUCTURE TO REMAIN UNDISTURBED

DEMOLITION GENERAL NOTES

- IF DEMOLITION COMMENCES PRIOR TO PERMIT, GC SHALL OBTAIN DEMO PERMITS AND INCLUDE ALL COSTS OF SAME IN CONTRACT PRICE, IF REQUIRED.
- FURNISH ALL LABOR AND MATERIALS AS REQUIRED TO COMPLETE DEMOLITION AND REMOVAL OF ALL ITEMS AS
- PROVIDE STRICT CONTROL OF JOB CLEANING AND PREVENT DUST AND DEBRIS FROM EMANATING FROM DEMOLITION AREA. KEEP AREA CLEAN.
- IF ANY QUESTIONS ARISE AS TO THE REMOVAL OF ANY MATERIAL, CLARIFY THE POINT IN QUESTION WITH THE ARCHITECT BEFORE PROCEEDING.
- 5. AT COMPLETION OF DEMOLITION WORK, THE CONSTRUCTION AREA(S) SHALL BE LEFT IN "BROOM CLEAN" CONDITION. ALL DEBRIS AND MISCELLANEOUS MATERIAL SHALL BE REMOVED ENTIRELY FROM THE CONSTRUCTION SITE ON A DAILY BASIS TO WASTE AREA PROVIDED BY THE CONTRACTOR.
- CLEAN ENTIRE SPACE, EVEN IF NOT PART OF CONSTRUCTION
- DEBRIS REMOVAL MUST BE PERFORMED IN ACCORDANCE WITH LANDLORD \$ BUILDING MANAGEMENT REQUIREMENTS AND
- CONTRACTOR SHALL BE RESPONSIBLE FOR PATCHING AND/OR REPAIRING ANY DAMAGE CAUSED BY HIM OR HIS SUBCONTRACTORS TO EXISTING CONSTRUCTION. REFINISH TO TI DRAWINGS & SPECIFICATIONS MATCH EXISTING ADJACENT FINISH, OR AS NOTED HEREIN.
- DEMOLITION IS NOT NECESSARILY LIMITED TO WHAT IS SHOWN ON DRAWINGS. THE INTENT IS TO INDICATE THE GENERAL SCOPE OF DEMOLITION REQUIRED TO COMPLETE THE WORK IN ACCORDANCE WITH THE CONTRACT DRAWINGS.
- . CONTRACTOR TO COORDINATE LOCATION OF DUMP SITE \sharp AL DEMO WORK WITH LANDLORD.
- CONTRACTOR TO REMOVE AND REINSTALL ROOF TOP MECHANICAL EQUIPMENT AND RELATED CONDUITS, AS WELL AY LIGHTING PROTECTION RODS AND CONNECTIONS, AS NEEDED

OWNER TO PROVIDE LETTER OF RECERTIFICATION FOR

- 2. ANY CURB UNDER 8" HIGH TO BE RAISED MINIMUM 8" HIGH ABOVE ROOF SURFACE.
- . AREAS OF SUBSTANTIAL DECK DEFLECTION OR MEMBRANE IMPERFECTIONS SHALL BE CORRECTED PRIOR TO INSTALLING ANY NEW ROOFING. FIELD VERIFY CONDITIONS

OUGH (

JVB ARCHITECT, LL

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FINAL OWNER REVIEW SET 7-8-2

REVISIONS

Joseph V. Belluccia, AIA

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COMPLY WITH THE APPLICABLE MINIMUM BUILDING CODES

JOB NO:

DRAWN BY:


ISSUE DATE:

SHEET TITLE: **LI** EXISTING/DEMO ROOF PLAN BUILDING 2

SHEET NUMBER


A-003


EXISTING/DEMO ROOF PLAN (EAST) - ALTERNATE 2

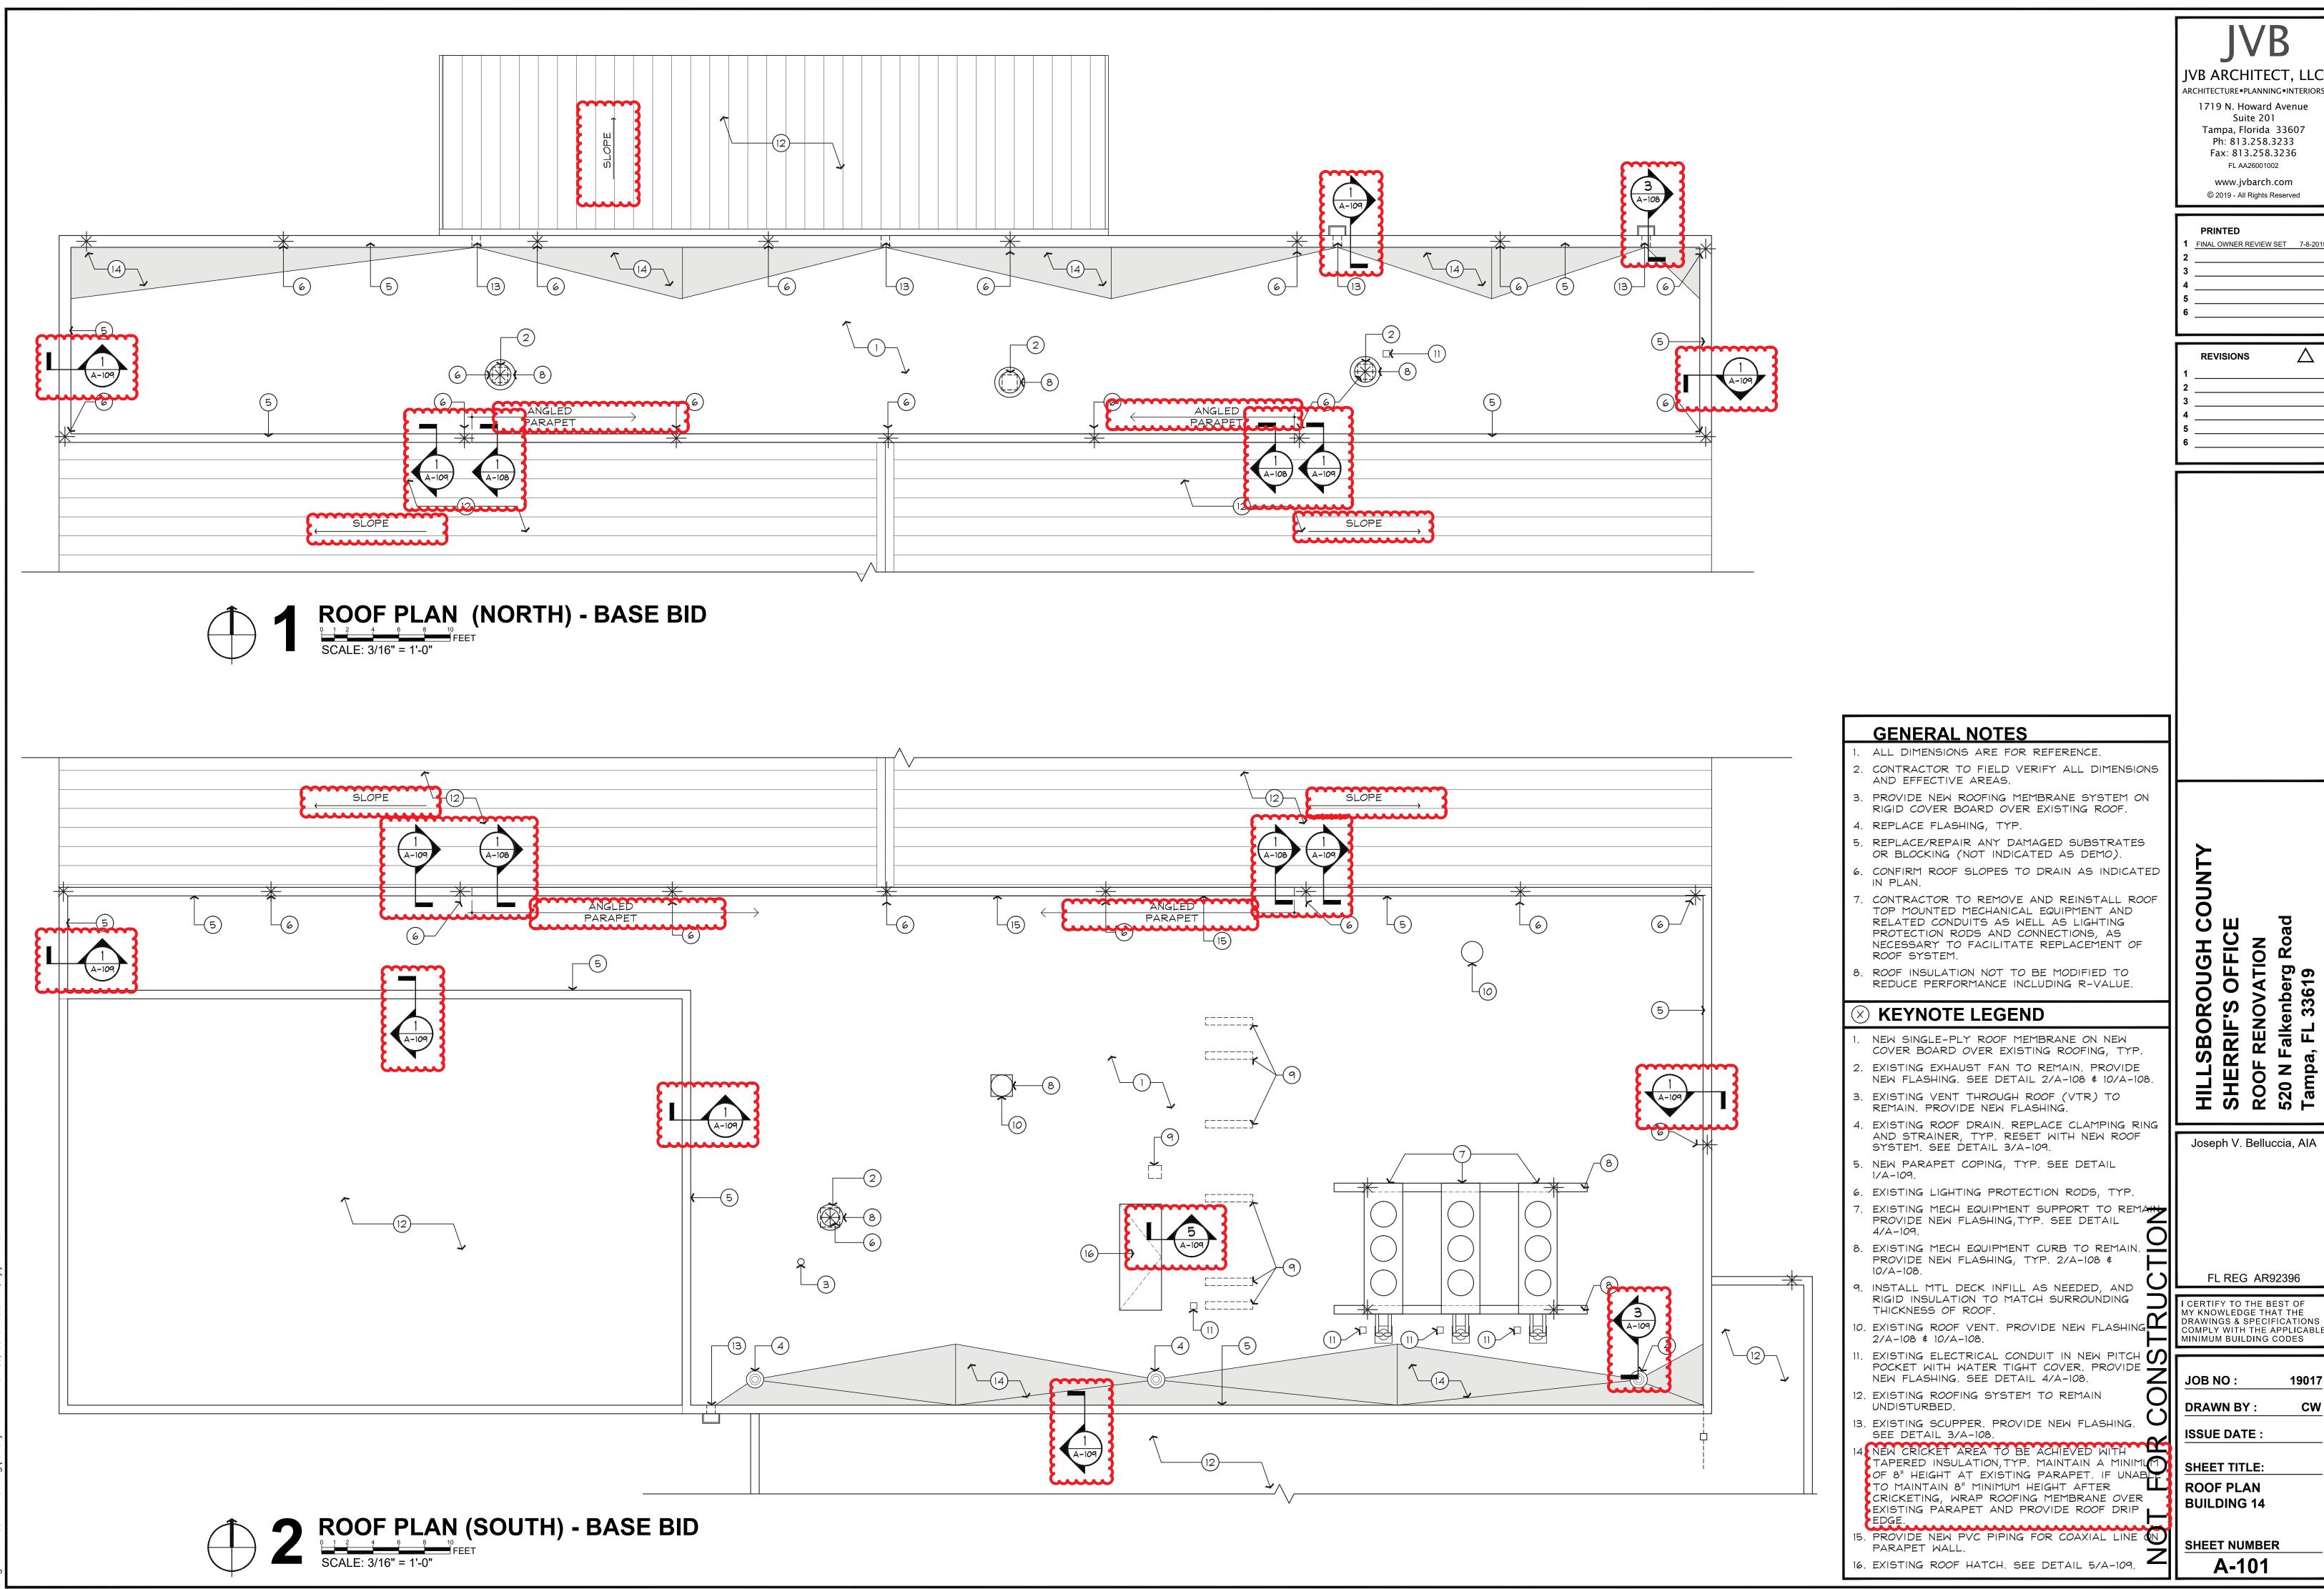

FINAL OWNER REVIEW SET 7-8-20

DRAWINGS & SPECIFICATIONS COMPLY WITH THE APPLICABLE MINIMUM BUILDING CODES

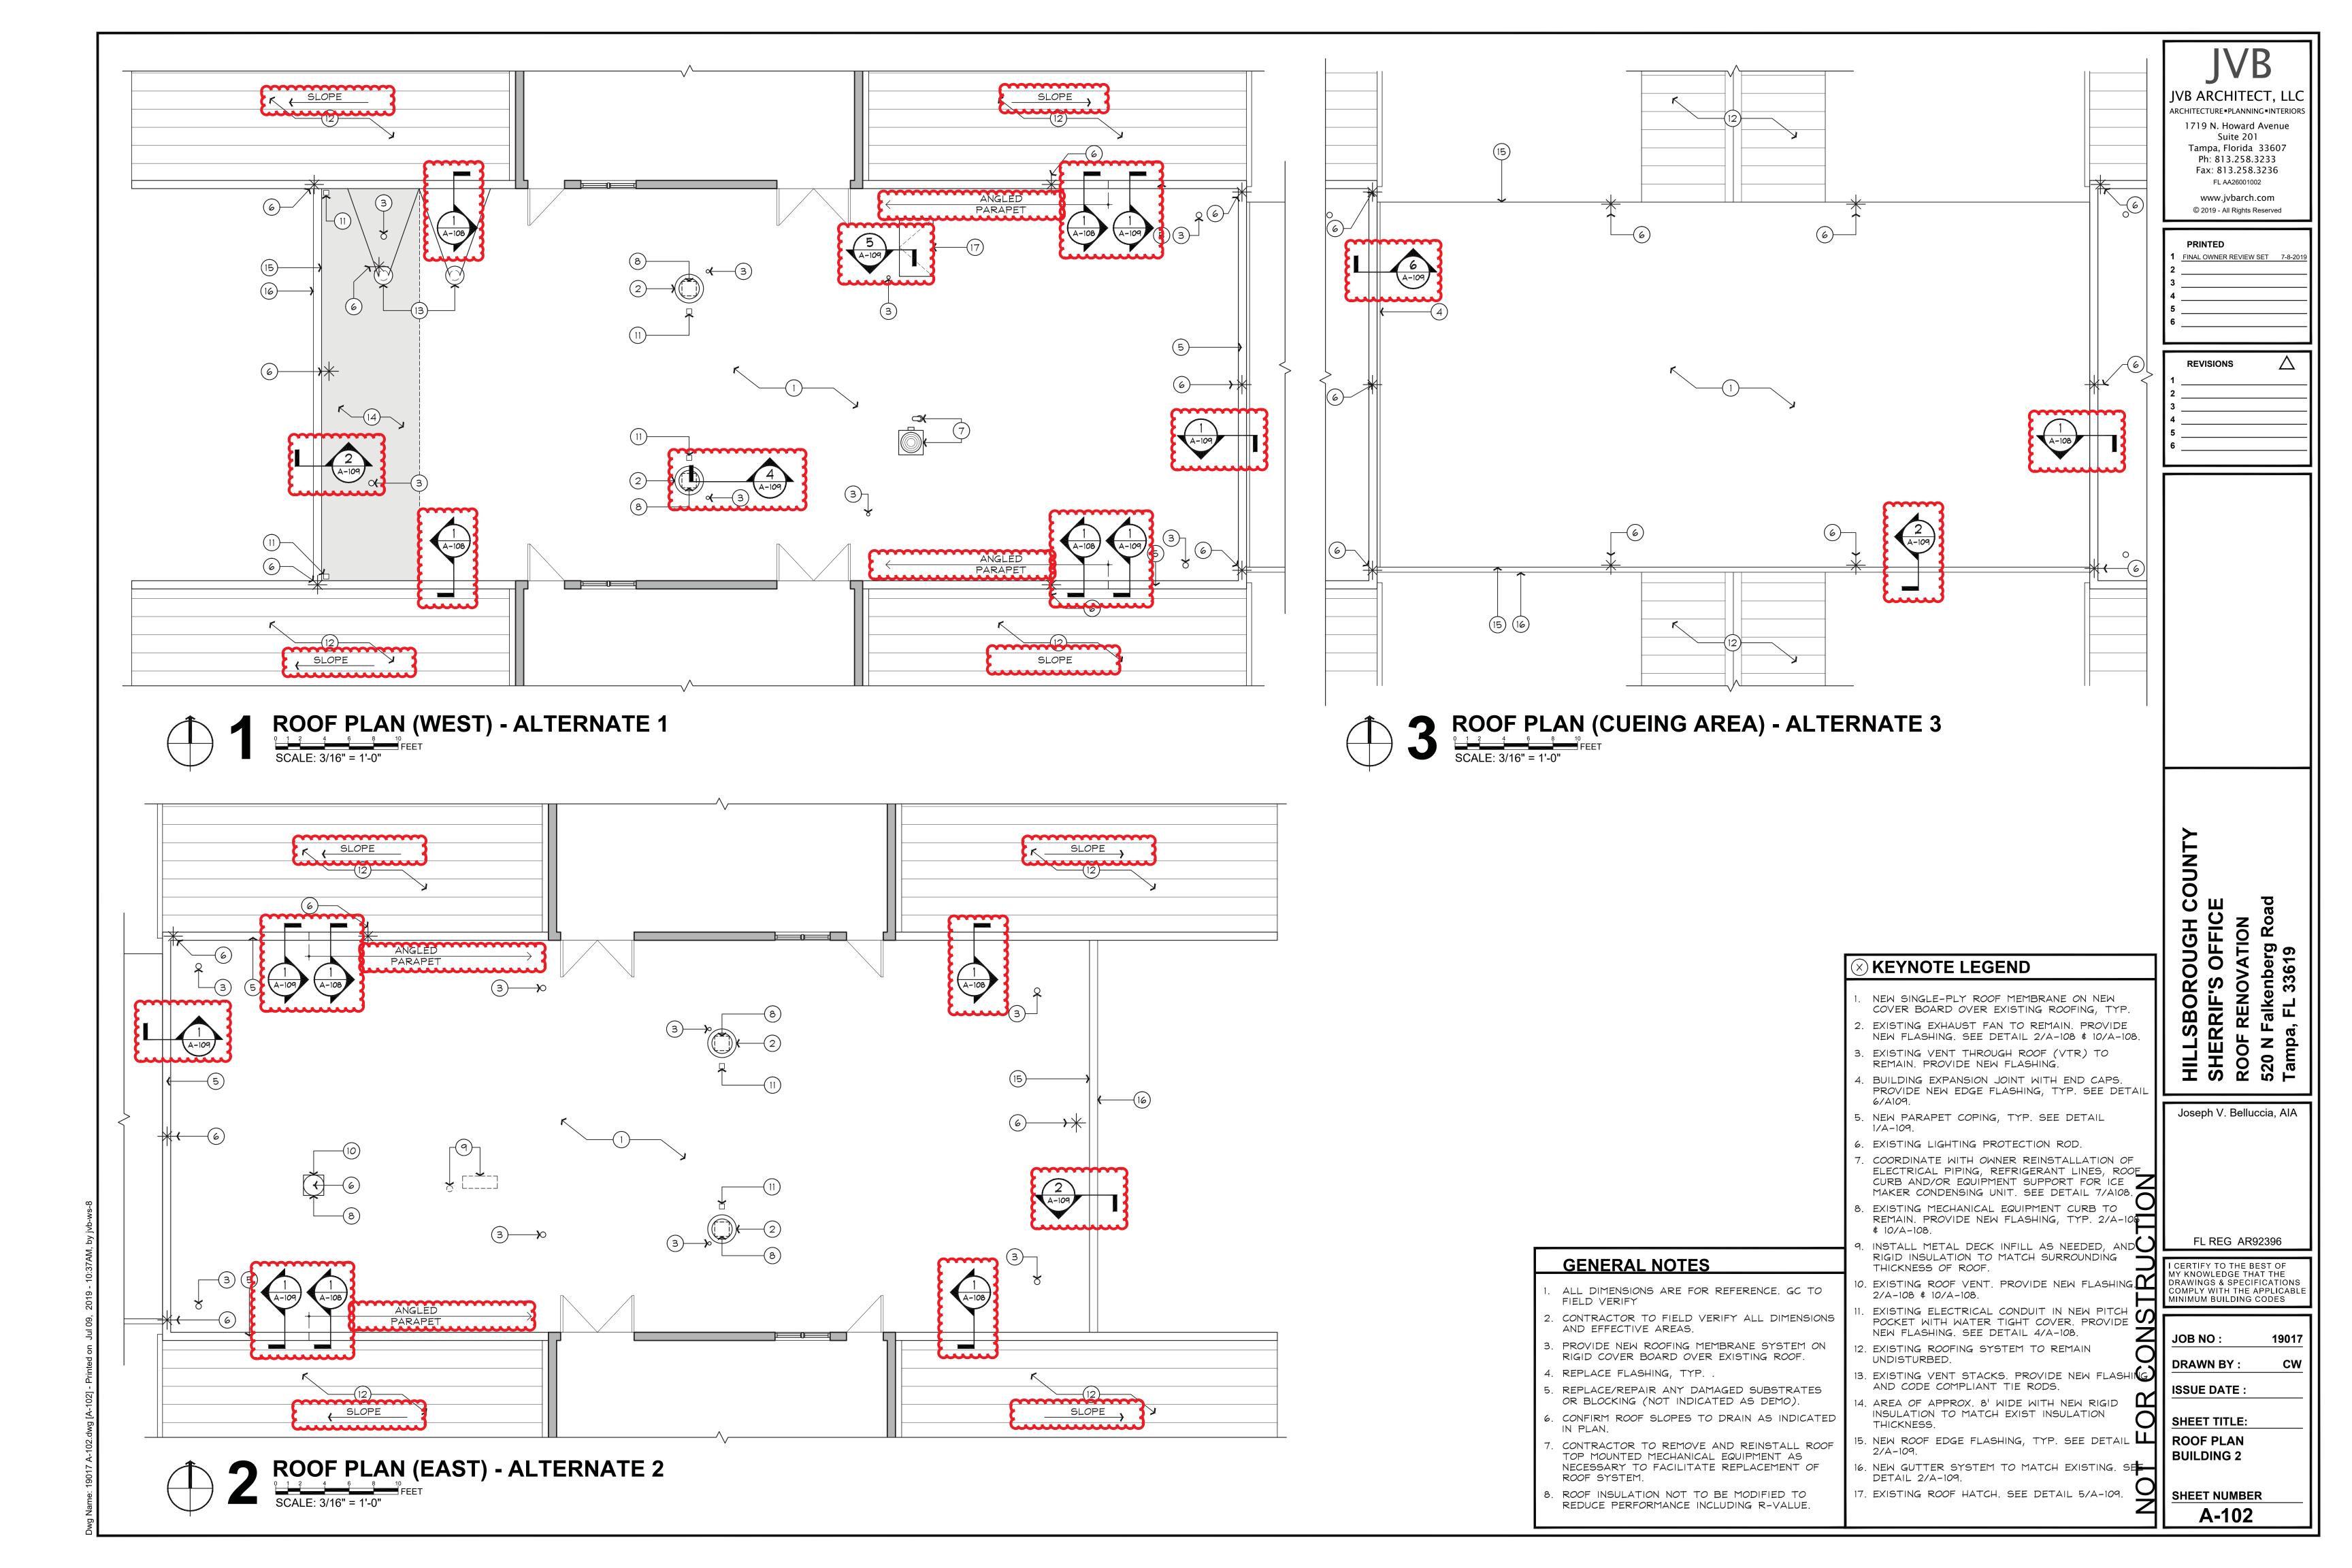

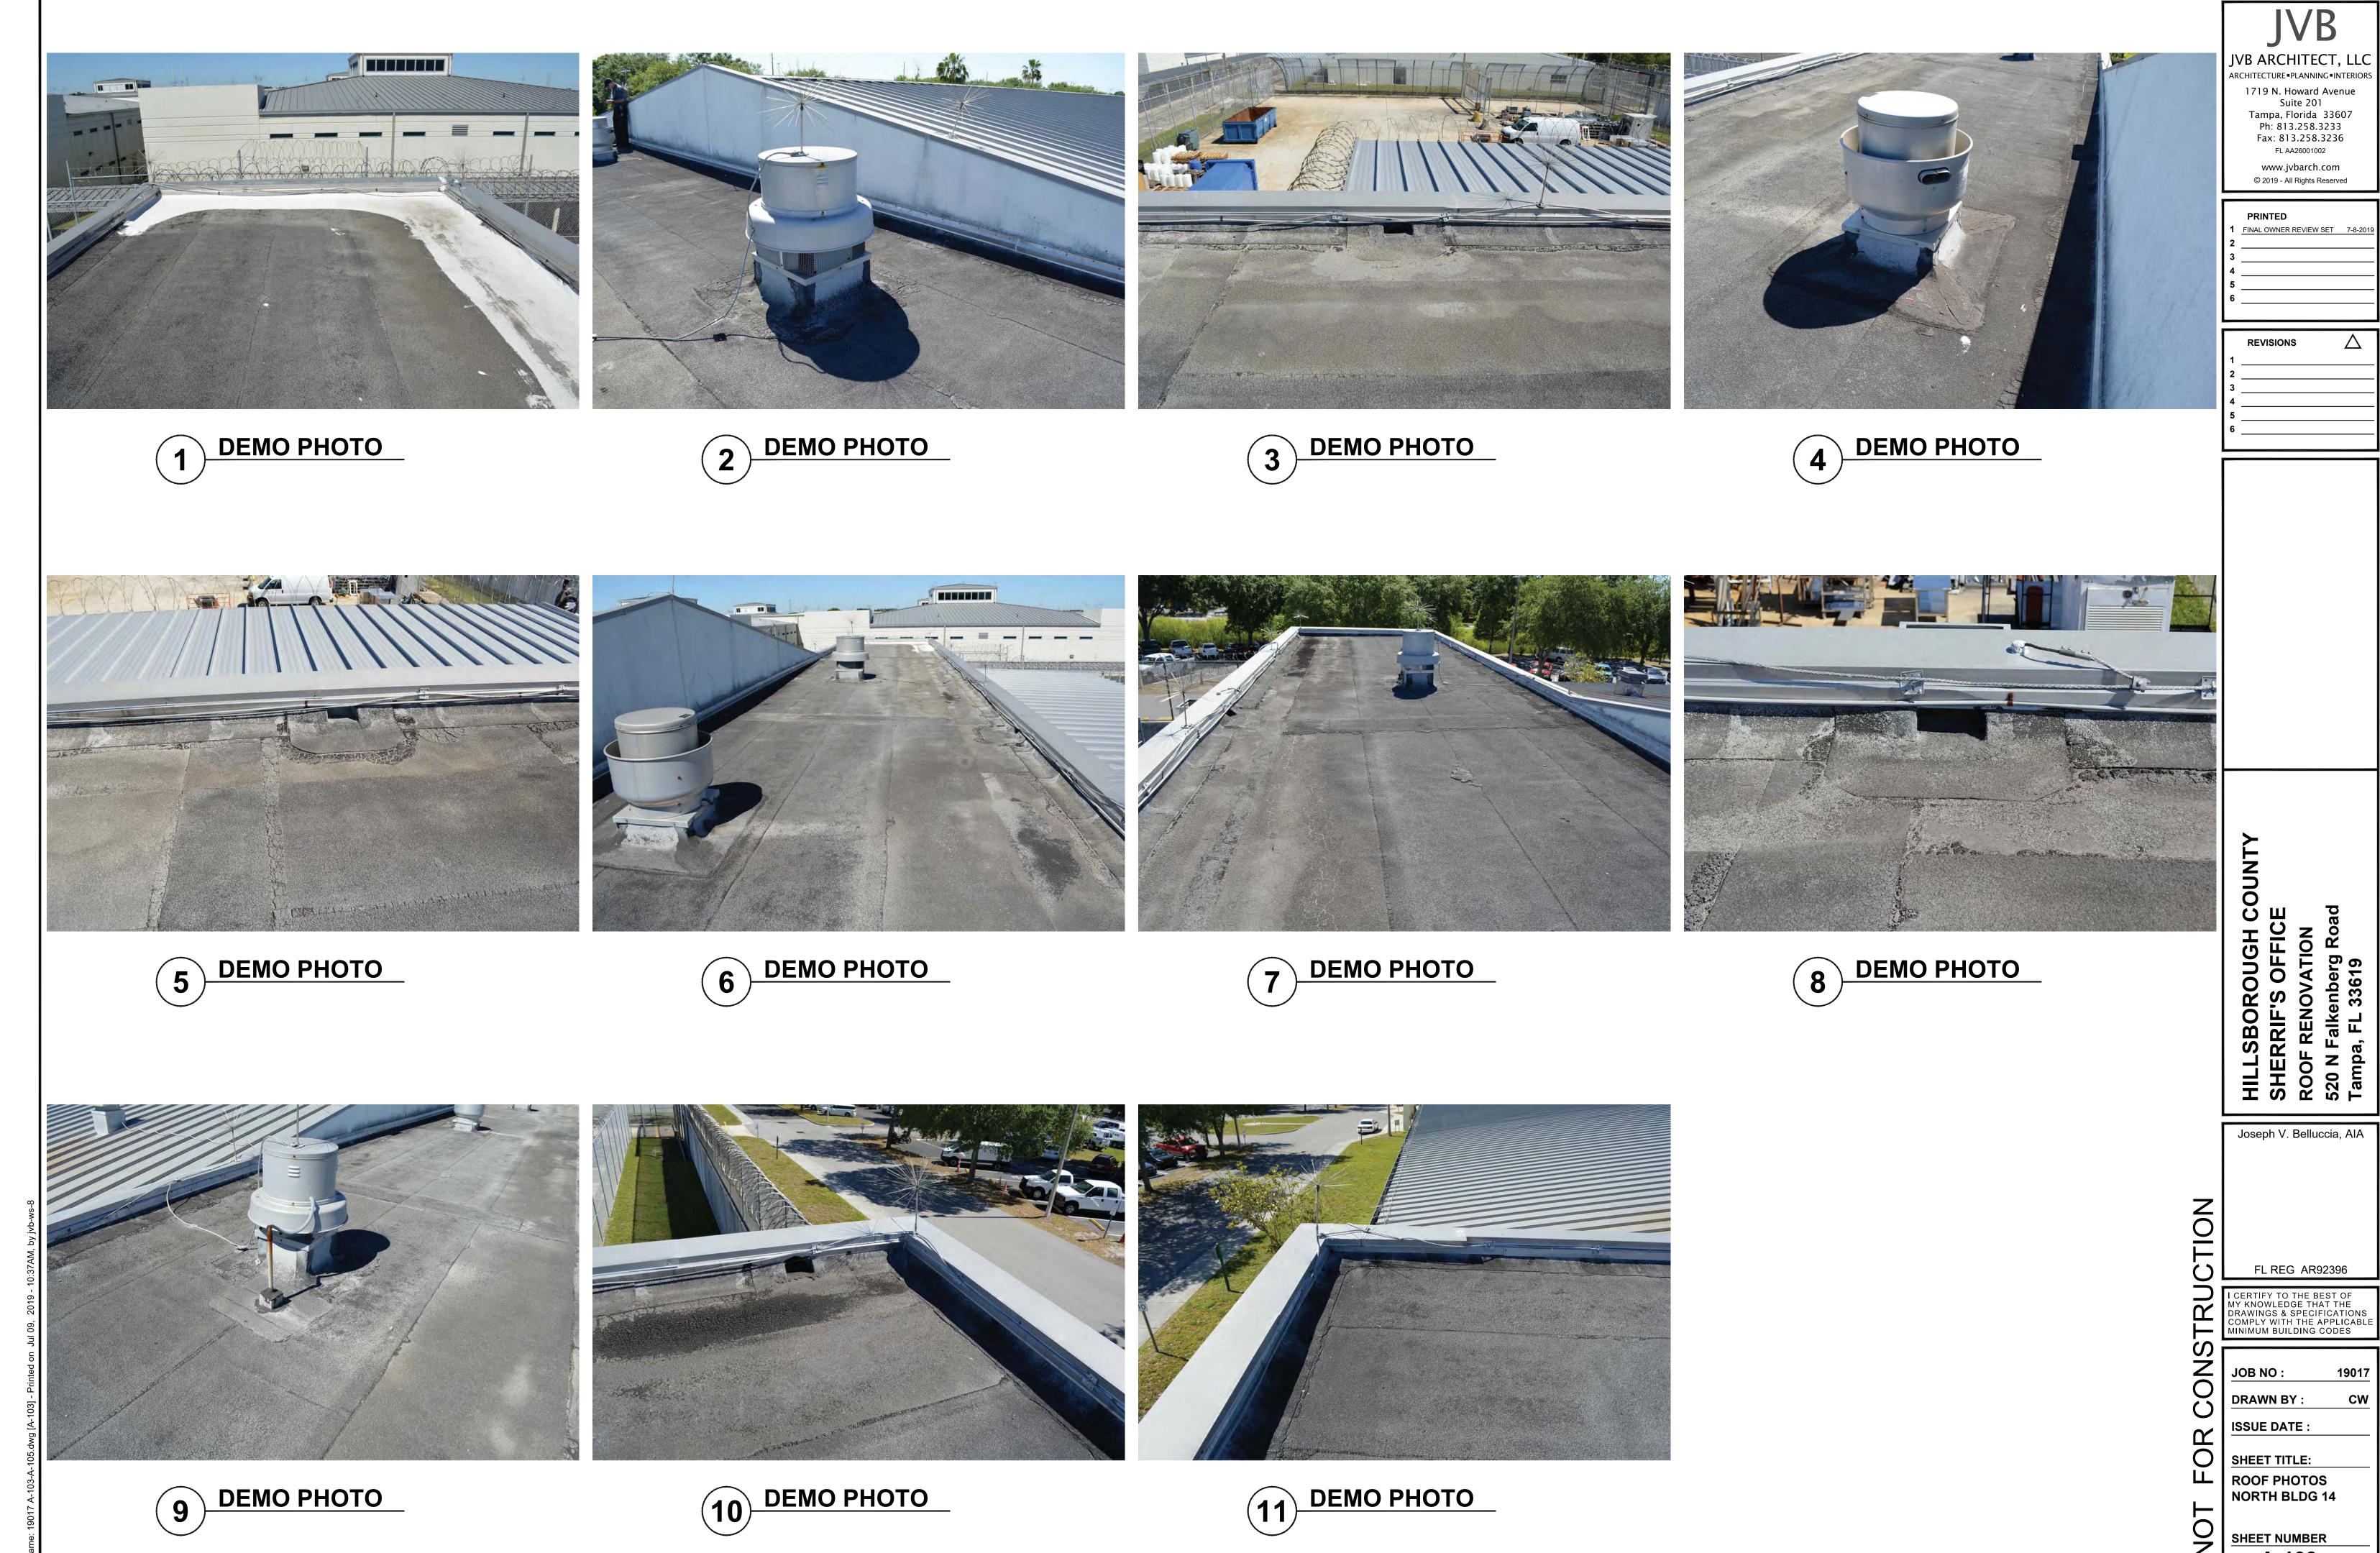


1719 N. Howard Avenue Tampa, Florida 33607

FINAL OWNER REVIEW SET 7-8-2

Joseph V. Belluccia, AIA

A-103

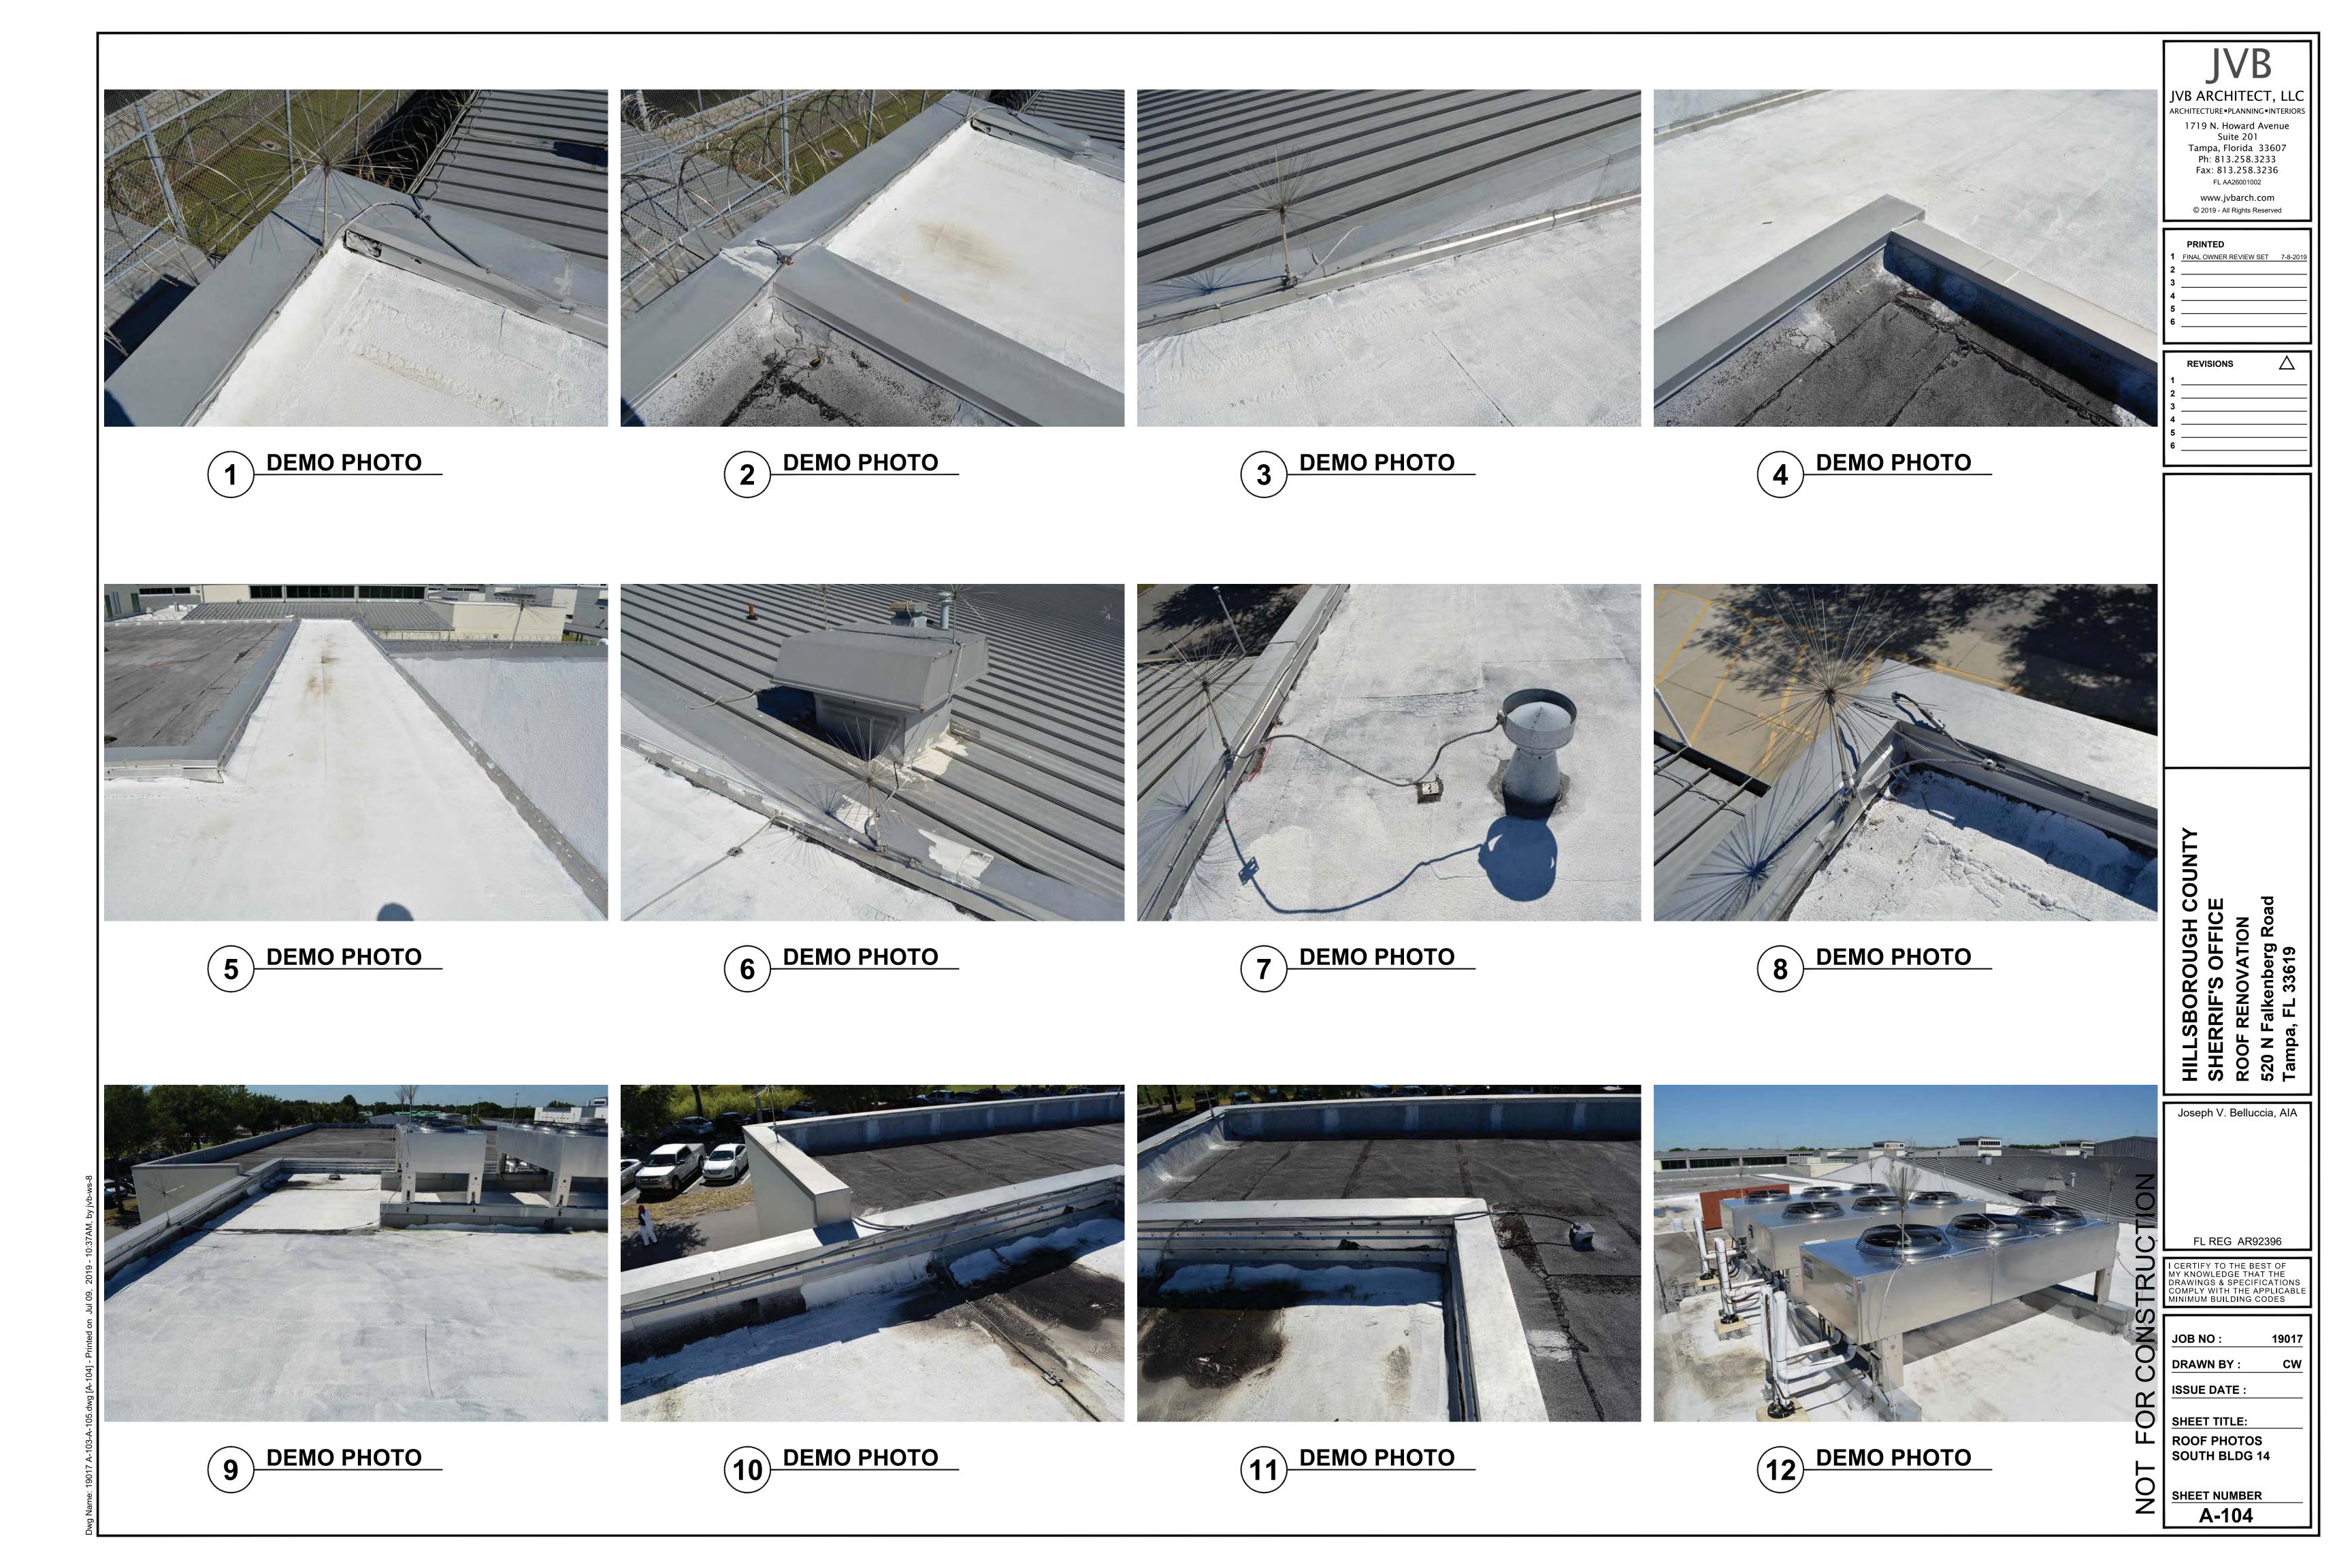









1719 N. Howard Avenue Suite 201

REVISIONS

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HILLSBOROUGH COUNTY
SHERRIF'S OFFICE
ROOF RENOVATION
520 N Falkenberg Road
Tampa, FL 33619

Joseph V. Belluccia, AIA

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FL REG AR92396

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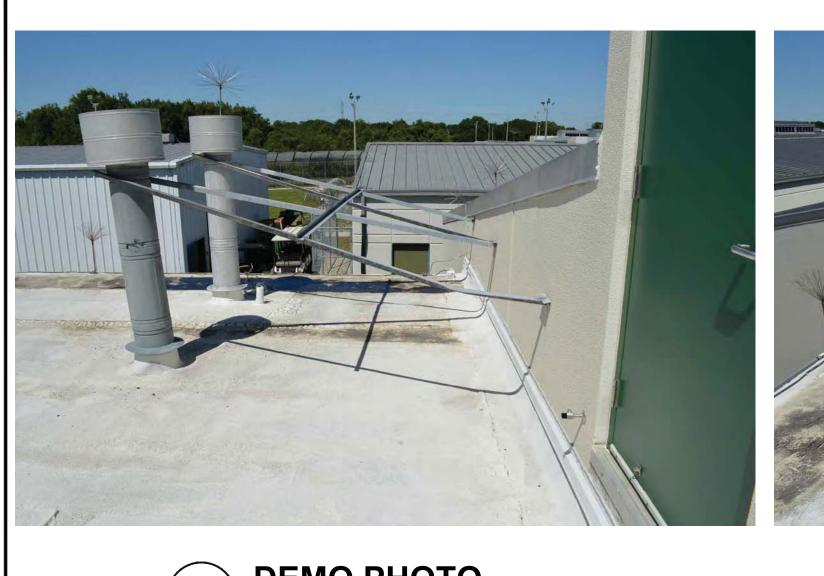
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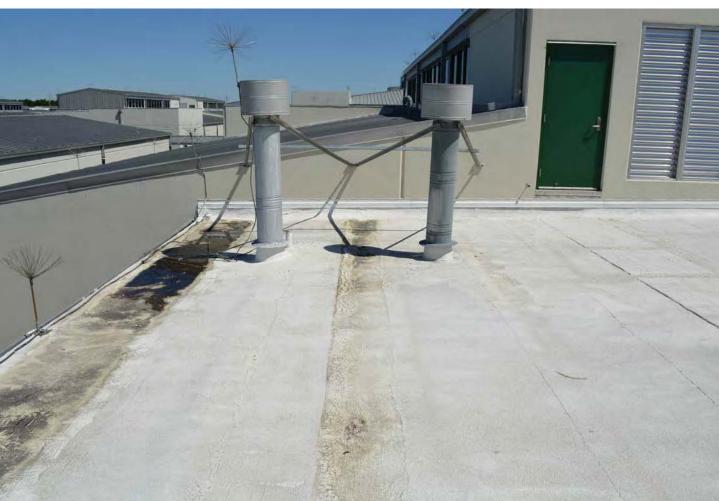
JOB NO :
DRAWN BY :

ISSUE DATE :

SHEET TITLE:
ROOF PHOTOS
SOUTH BLDG 14

SHEET NUMBER 105









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DEMO PHOTO



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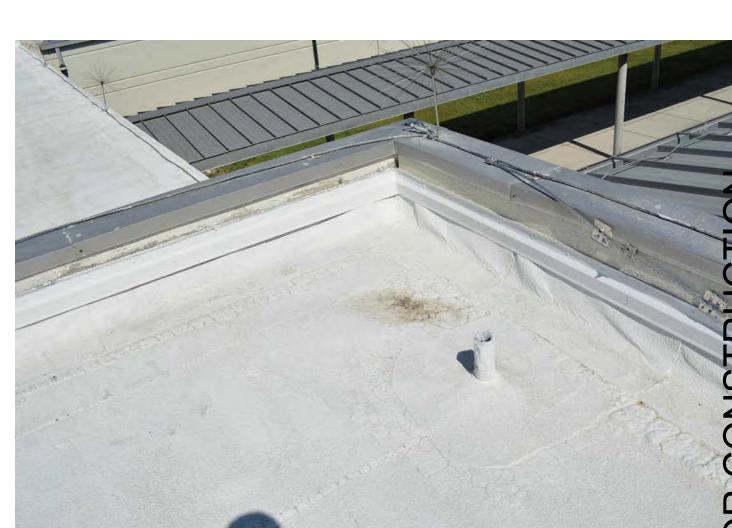
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FL REG AR92396


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ISSUE DATE :

SHEET TITLE: LL ROOF PHOTOS WEST BLDG 2

> SHEET NUMBER A-106





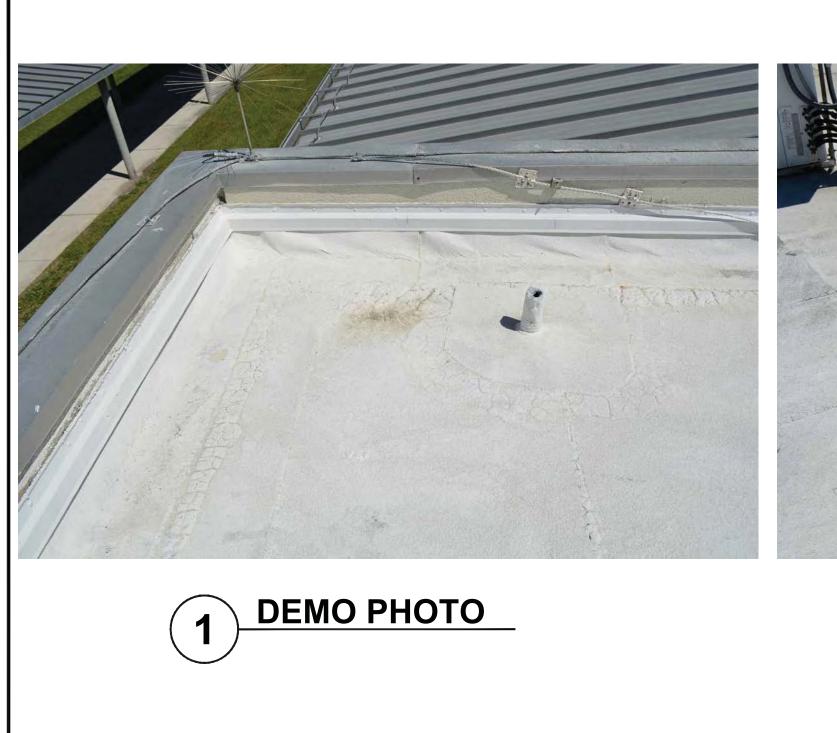




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FL REG AR92396


Joseph V. Belluccia, AIA


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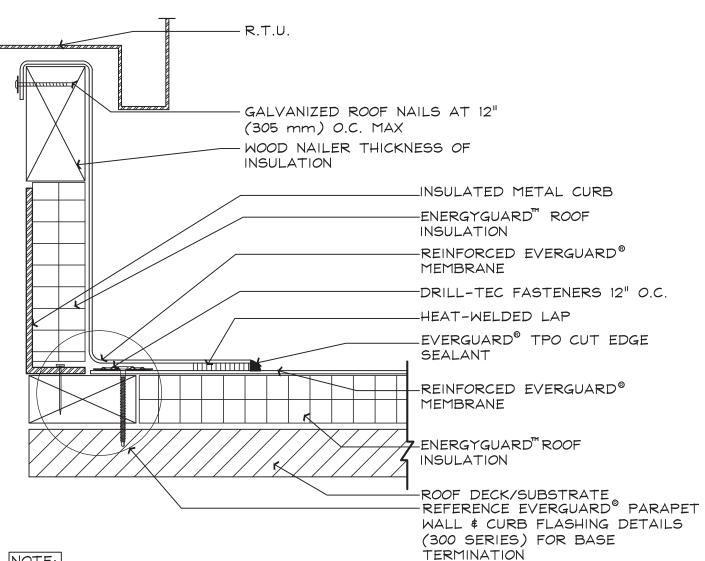
SHEET TITLE: ROOF PHOTOS EAST BLDG 2

SHEET NUMBER A-107

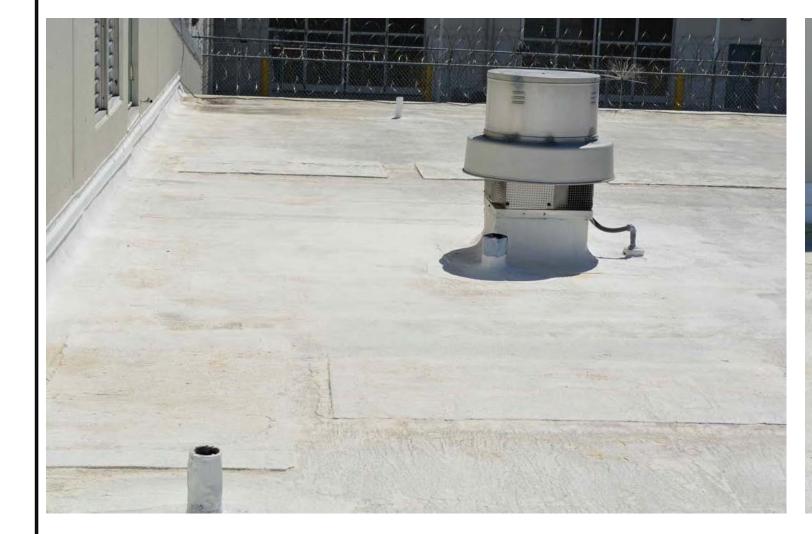

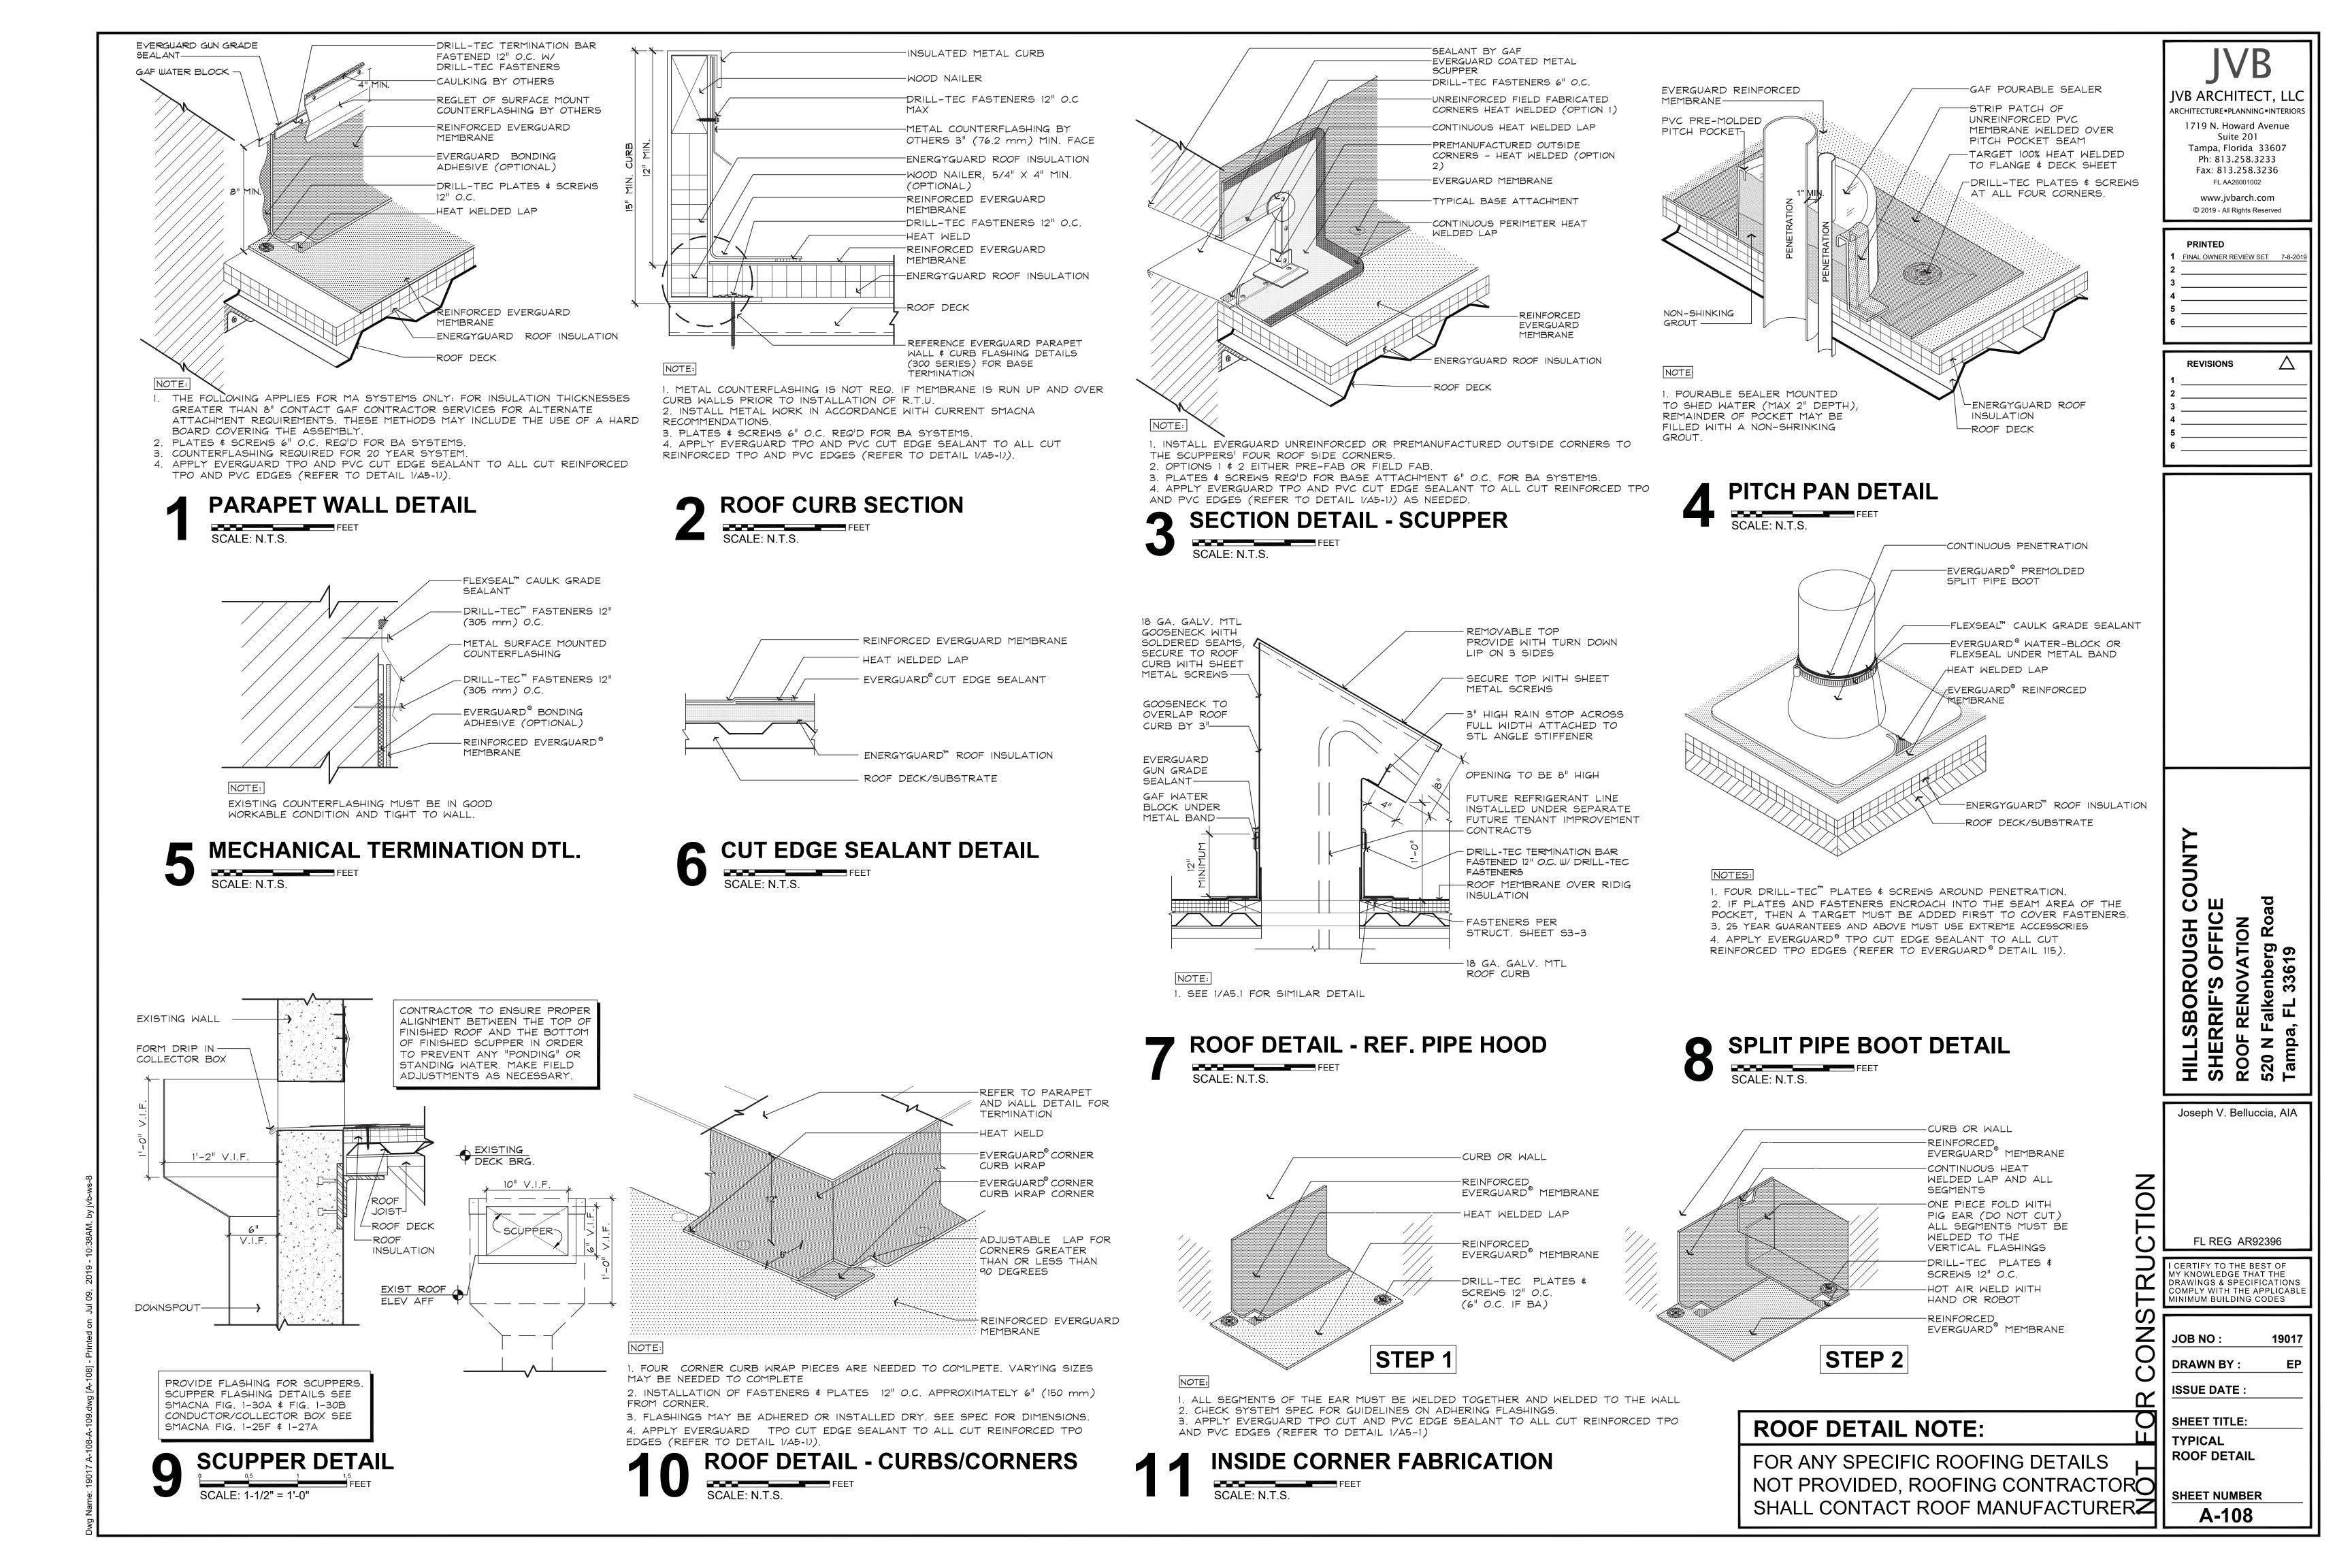

WALL CAP DETAIL SCALE: N.T.S.

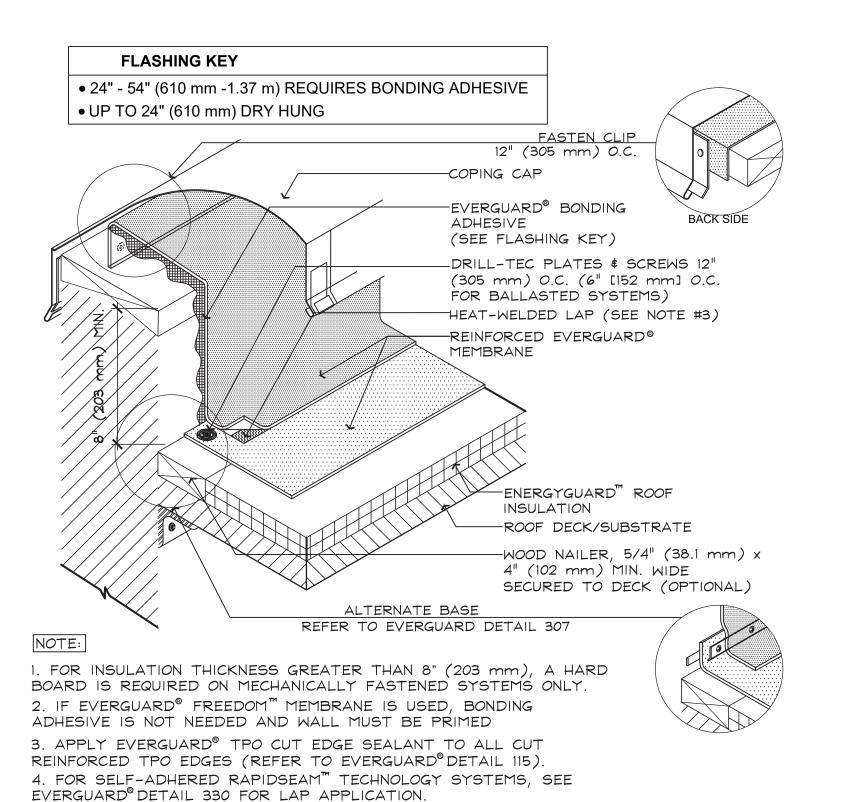


1. FOR INSULATION THICKNESS GREATER THAN 8" (203 mm), A HARD BOARD IS REQUIRED ON MECHANICAL SYSTEMS ONLY. 2. FOR SELF-ADHERED RAPIDSEAM TECHNOLOGY SYSTEMS, SEE EVERGUARD DETAIL 330 FOR LAP APPLICATION.

3. IF EVERGUARD® FREEDOM™ MEMBRANE IS USED, BONDING ADHESIVE IS NOT NEEDED AND WALL MUST BE PRIMED.

4. APPLY EVERGUARD® TPO CUT EDGE SEALANT TO ALL CUT REINFORCED TPO EDGES (REFER TO EVERGUARD® DETAIL 115).

TERMINATION @ R.T.U. SCALE: N.T.S.

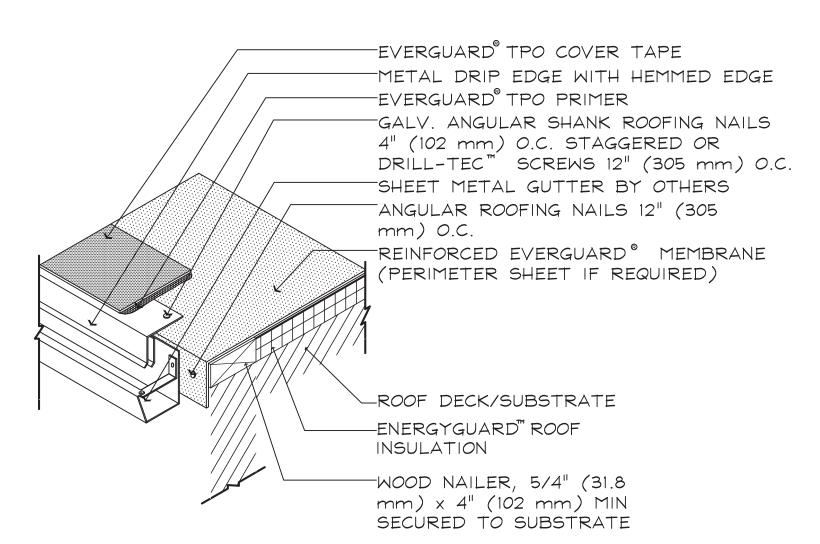


SCALE: N.T.S.

1. CLEAN METAL AND MEMBRANE WITH EVERGUARD® TPO SEAM CLEANER AND ALLOW TO DRY BEFORE PRIMING. 2. EVERGUARD® TPO COVER TAPE ONLY TO BE USED WITH TPO MEMBRANE

3. FOR INSULATION THICKNESS GREATER THAN 8" (203 mm), A HARD BOARD IS REQUIRED ON MECHANICALLY FASTENED SYSTEMS ONLY. 4. APPLY EVERGUARD® TPO CUT EDGE SEALANT TO ALL CUT REINFORCED TPO EDGES (REFER TO EVERGUARD® DETAIL 115).


COVER TAPE AT GUTTER EDGE DTL.

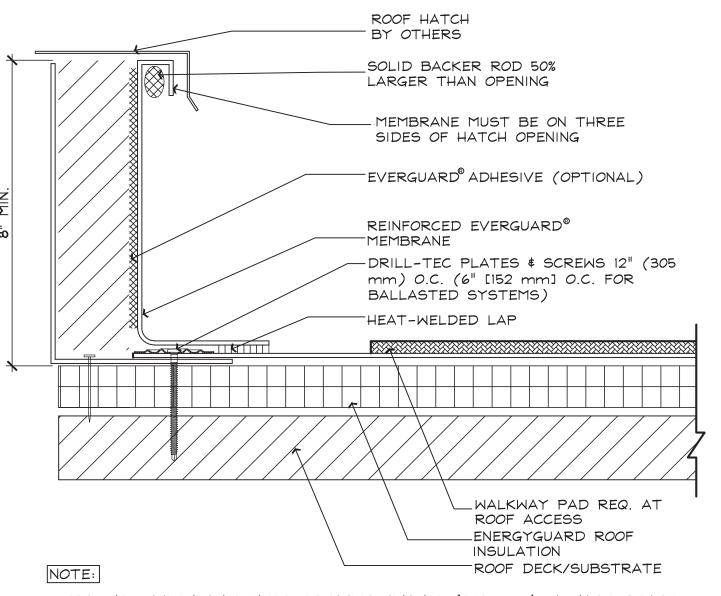

1. FOR INSULATION THICKNESS GREATER THAN 8" (203 mm), A HARD BOARD IS REQUIRED ON MECHANICAL SYSTEMS ONLY. 2. IF EVERGUARD® FREEDOM MEMBRANE IS USED, BONDING ADHESIVE IS NOT NEEDED AND WALL MUST BE PRIMED. 3. FOR SELF-ADHERED RAPIDSEAM TECHNOLOGY SYSTEMS, SEE

EVERGUARD® DETAIL 330 FOR LAP APPLICATION. 4. APPLY EVERGUARD TPO CUT EDGE SEALANT TO ALL CUT REINFORCED TPO EDGES (REFER TO EVERGUARD® DETAIL 115).

ROOF HATCH DETAIL SCALE: N.T.S.

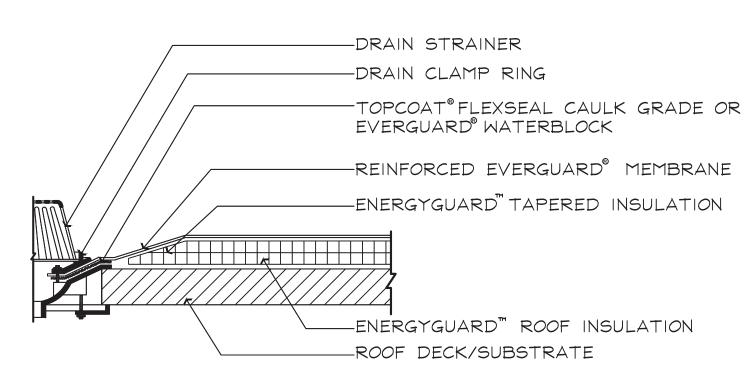


1. A FIELD WELD CANNOT PASS WITHIN 9" (227 mm) OF THE CLAMPING, OR WITHIN THE DRAIN SUMP ITSELF

2. MEMBRANE MUST EXTEND MINIMUM I" (25.4 mm) BEYOND THE BOLT HOLES. THE CLAMPING RING BOLTS MUST PENETRATE THE MEMBRANE.

3. TAPERED INSULATION TO CREATE A ROOF SUMP MINIMUM 36" (0.914 m) x 36" (0.914 m) IN SIZE. (IF APPLICABLE)

4. USE ONE FULL TUBE OF FLEXSEAL™ CAULK GRADE SEALANT OR EVERGUARD WATER BLOCK PER DRAIN.

5. ASPHALT OR STONE PAVER MUST STOP AT DRAIN TAPER. STANDARD ROOF DRAIN FLASHING DTL.

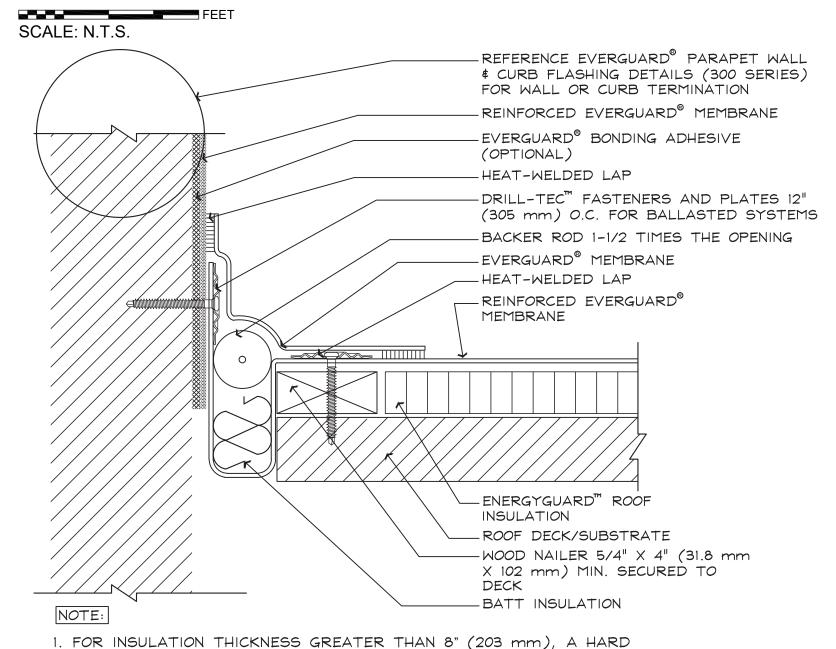

BOARD IS REQUIRED ON MECHANICALLY SYSTEMS ONLY. 2. FIELD-FABRICATED EXPANSION JOINT SHOULD USE A SMOOTH BACKED

3. APPLY EVERGUARD® TPO CUT EDGE SEALANT TO ALL CUT REINFORCED TPO EDGES (REFER TO EVERGUARD® DETAIL 115).

FIELD FABRICATED WALL EXPANSION. JOINT DTL. Z SCALE: N.T.S.

FL REG AR92396 MY KNOWLEDGE THAT THE RAWINGS & SPECIFICATIONS OMPLY WITH THE APPLICABLE MINIMUM BUILDING CODES

S W

HILLSBOROUGH C SHERRIF'S OFFICE ROOF RENOVATION 520 N Falkenberg Road Fampa, FL 33619

HILL SHEF ROOF 520 N Tamp

Joseph V. Belluccia, AIA

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ARCHITECTURE *PLANNING *INTERIORS

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Fax: 813.258.3236

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FINAL OWNER REVIEW SET 7-8-20

REVISIONS

JOB NO: 19017 **DRAWN BY:**

ISSUE DATE:

SHEET TITLE: **TYPICAL ROOF DETAIL**

SHEET NUMBER A-109

ROOF DETAIL NOTE:

FOR ANY SPECIFIC ROOFING DETAILS NOT PROVIDED, ROOFING CONTRACTOR SHALL CONTACT ROOF MANUFACTURERZ